

Date: 10/01/2025

Project Number: 41-3097-25

Project Name: Ada War Memorial Park - New Concession Stand and Shelter House

Intent:

This Addendum provides modifications and clarifications To the Bid Documents dated **September 9, 2025** Bidder shall ascertain prior to submitting its Bid Form that it has received all Addenda issued and shall acknowledge receipt of each Addendum on the Bid Form.

In the event of a conflict between the terms and provisions of this Addendum and the terms and provisions of the Bidding Documents, the terms and provisions of this Addendum shall control. In all other respects, the Bidding Documents shall remain unchanged and in full force and effect.

Item	Additional Document	Cons. Doc. Reference	Description
Specif	ications:		
1	APPROVED SUBSTITUTION		ADD AS AN APPROVED EQUAL: De La Fontaine to Hollow Metal Doors and Frames Specification.
2		081113 HOLLOW METAL DOORS AND FRAMES	ADD AS AN APPROVED EQUAL: Dimensional Metals, Inc. (DMI), Metal Panel Systems.
Civil:			
3	ISSUE DRAWING SHEETS C100,C101, & C300		ISSUE: Drawing Sheets C100, C1012 and C300 for the Concession Stand.
4	ISSUE DRAWING SHEETS C100, C101, & C300		<b>ISSUE:</b> Drawing Sheets C100, C101, and C300 for the Shelter House.
Archite	ectural:		
5	REISSUE SHEETS A-1 AND A-3		REISSUE SHEETS A-1 AND A-3 FOR THE SHELTER HOUSE: Added notes for inclusion of (2) 6" PVC sleeves (capped) through the wall of the shelter house.
6	REISSUE SHEETS A-1 AND A401		REISSUE SHEET A-1 FOR THE SHELTER HOUSE AND A401 FOR THE CONCESSION STAND: Door hardware set #1 has been revised. The concealed overhead stop has been replaced with a surface mounted overhead stop. A closer has been included in the door hardware.

Electri	Electrical:					
7	ISSUE ELECTRICAL SITE PLAN E100		ISSUE: Sheet E100 for the shelter house.			
8	REISSUE DRAWING SHEET E101		REVISED FOR THE SHELTER HOUSE: Change rotation of North arrow. Added emergency light in Storage 102. Changed occupancy sensor to single pole switch in Storage 102.			
9	REISSUE DRAWING SHEET E501		REVISED FOR THE SHELTER HOUSE: Added LED emergency fixture to light fixture schedule. Added single pole switch to Lighting Legend.			
End of	End of Addendum 02					

## Technicon Design Group


### **Substitution Request Form**


Technicon Design Group 202 West Main Street, Suite 301, Ottawa, Ohio 45875 sandy@technicondesigngroup.com


Px 419.523.5323 Fx 419.523.9441

0.4.10404						
Drawing No.: A-1 / A401	Drawing Name:					
Spec. Section: 081113	Spec Name:	Hollow Metal Doors and Frames				
Article/Paragraph: 2.1A	Specified Item:	Manufacturer				
Proposed Substitution: De La Fontaine a	s the manufactu	rer				
Manfacturer: De La Fontaine		Model: Hollow Metal Doors and Frames				
Submit with this form substantiating data to pro approved equals. Clearly mark manufacturer's	1.5	,				
Does the Substitution affect dimensions shown	on Drawings? Ye	s No_x_ If yes, clearly indicate changes.				
Will changes be required to the Contract Docur substitution. Yes No_x If		er installation of the proposed product at indicates description of changes.				
What affect does substitution have on other Co None	ntracts or other tra	des?				
What affect does substitution have on the deliverable None	ery and construction	n schedule?				
Differences between proposed substitution and No difference	specified item.					
Manufacturer's warranties of proposed and spe	cified items are:					
Same: X Different:		Explain on an Attachment (Provide Warranty Information)				
Company Submitting Request: Ahner Commer	cial & Supply LLC					
Address: 2101 W Perkins Ave Sandusky OH 44	870					
Phone: 419-500-2101	Email:	michaelahner@ahnercommercial.com				
Signature/Title: Michael Ohner Estimator / Project Manager Date: 9/29/25						
For use by Technicon Design Group						
Accepted		Accepted as Noted				
Not Accepted		Received too Late				
Signature/Title:		Date: 10 - 1 - 25				

New Concession Stand and Shelter House Ada War Memorial Park 401 North Park Drive Ada, Ohio 45810

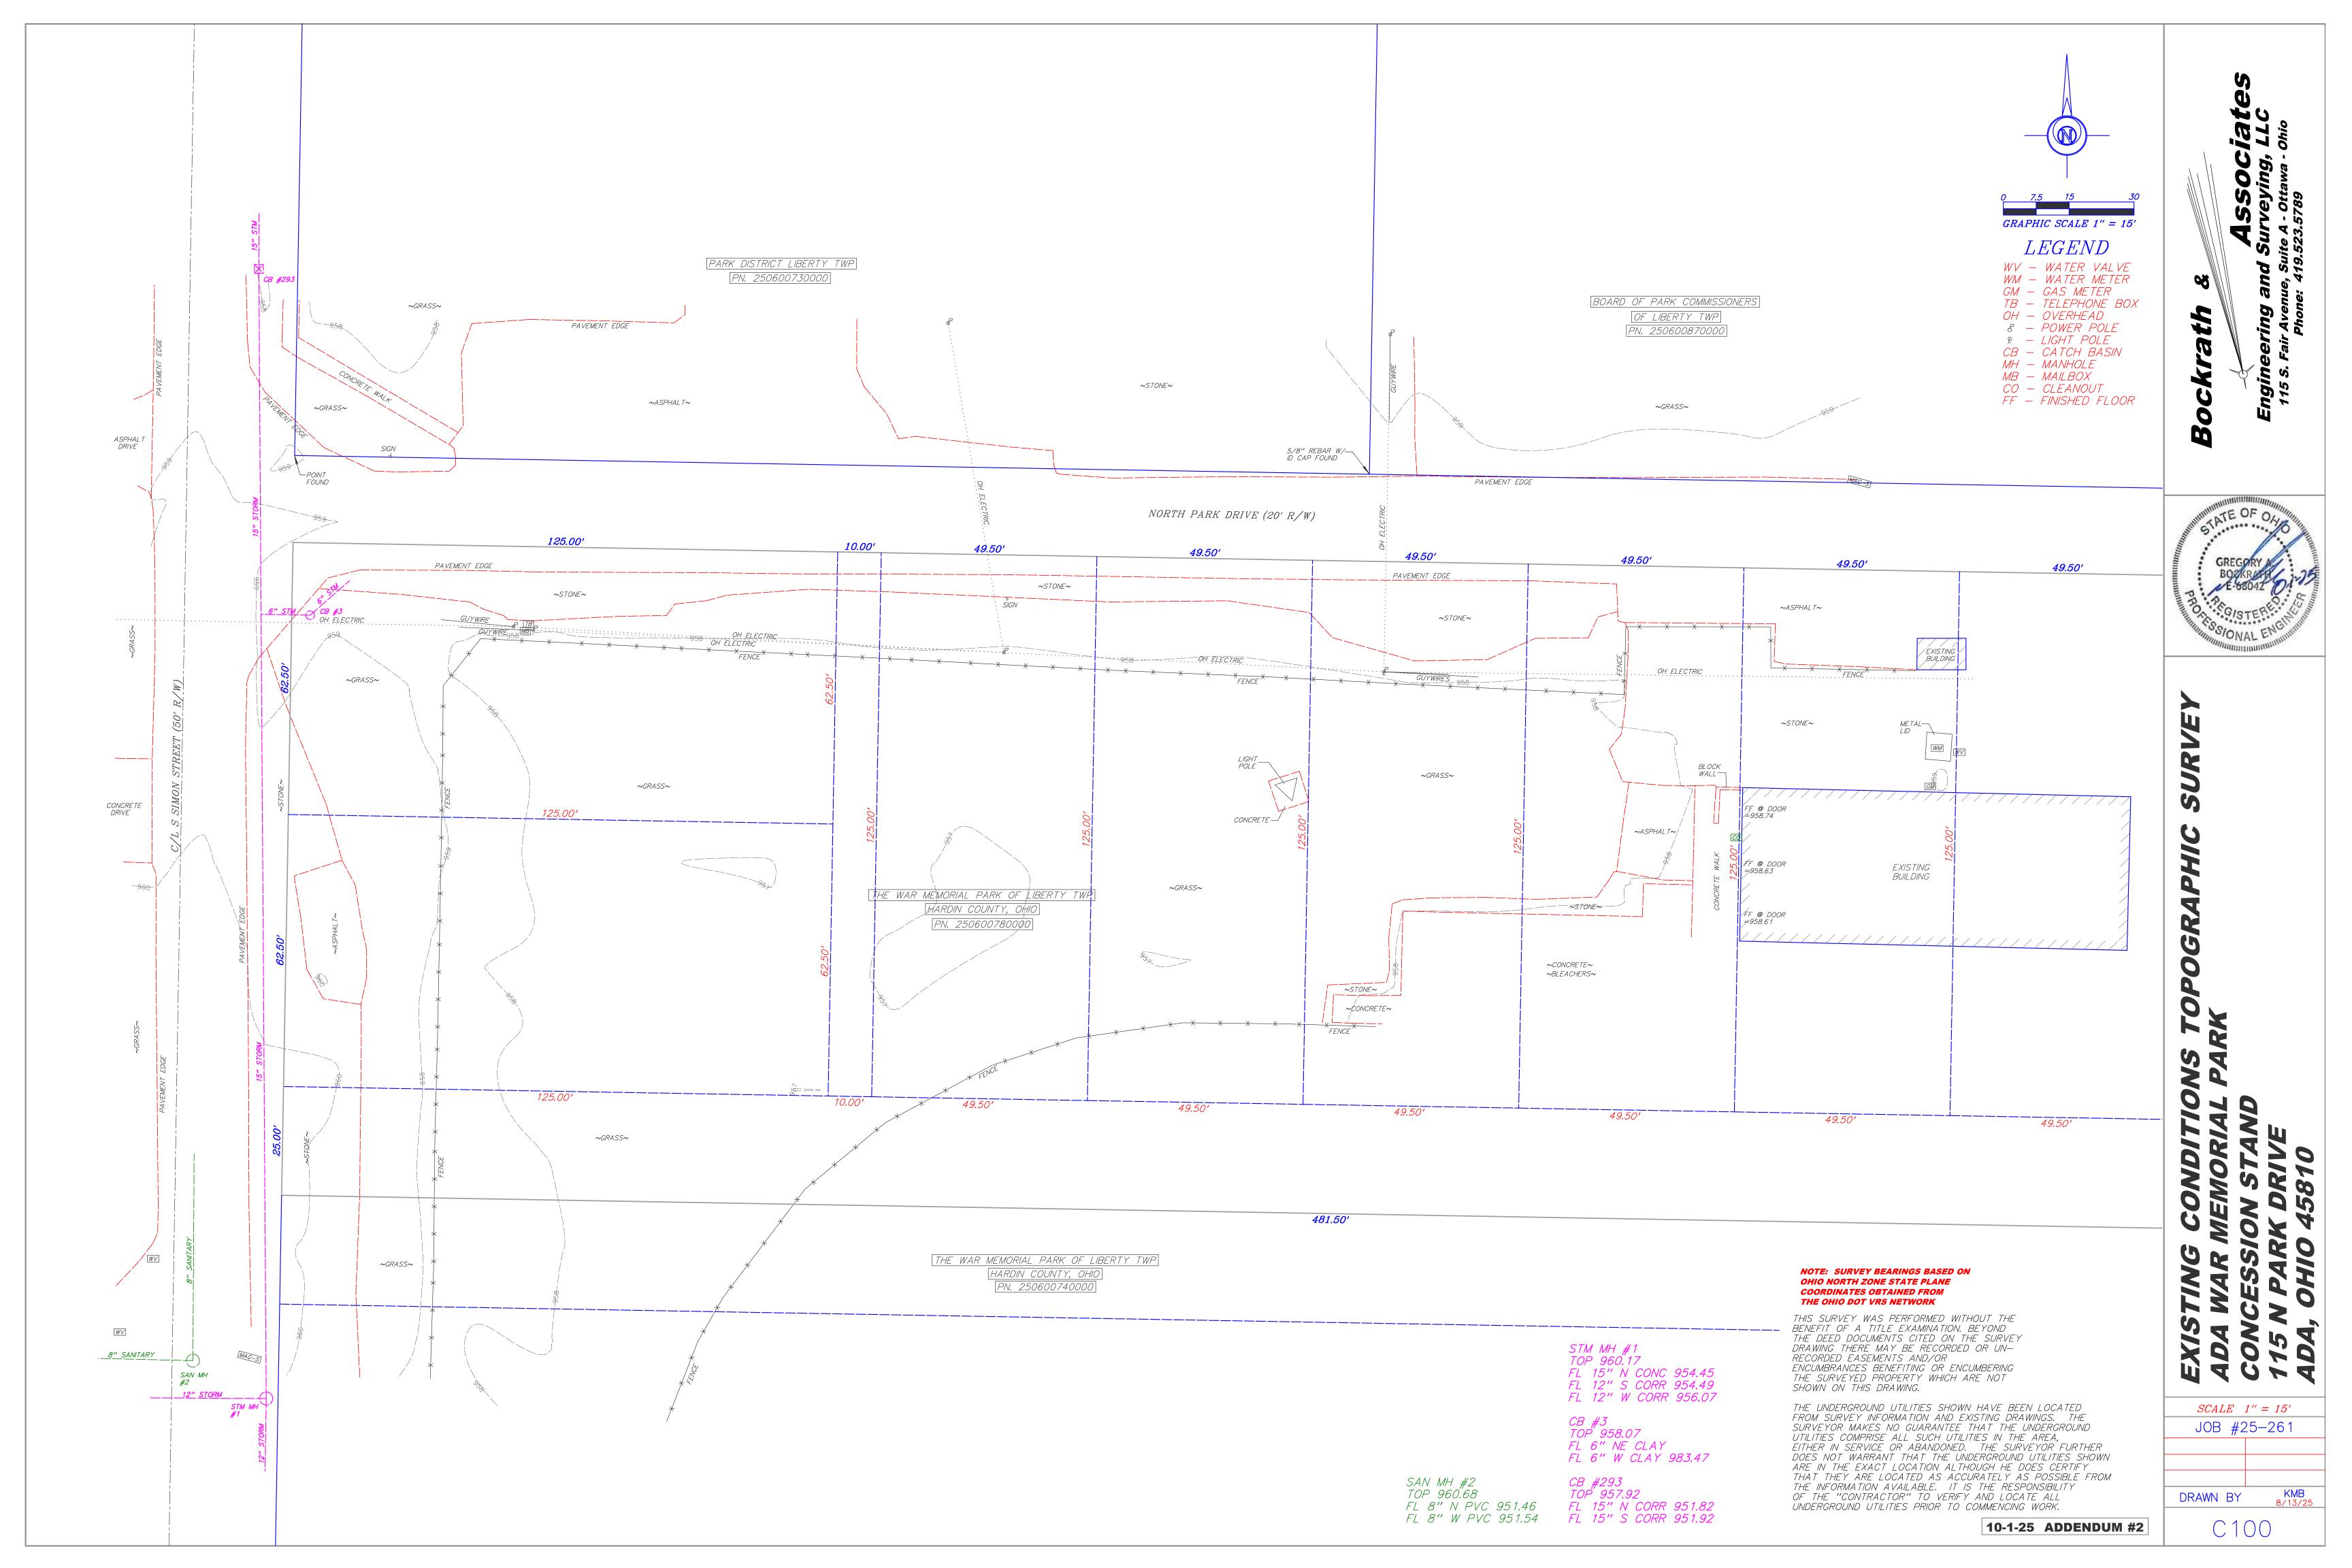

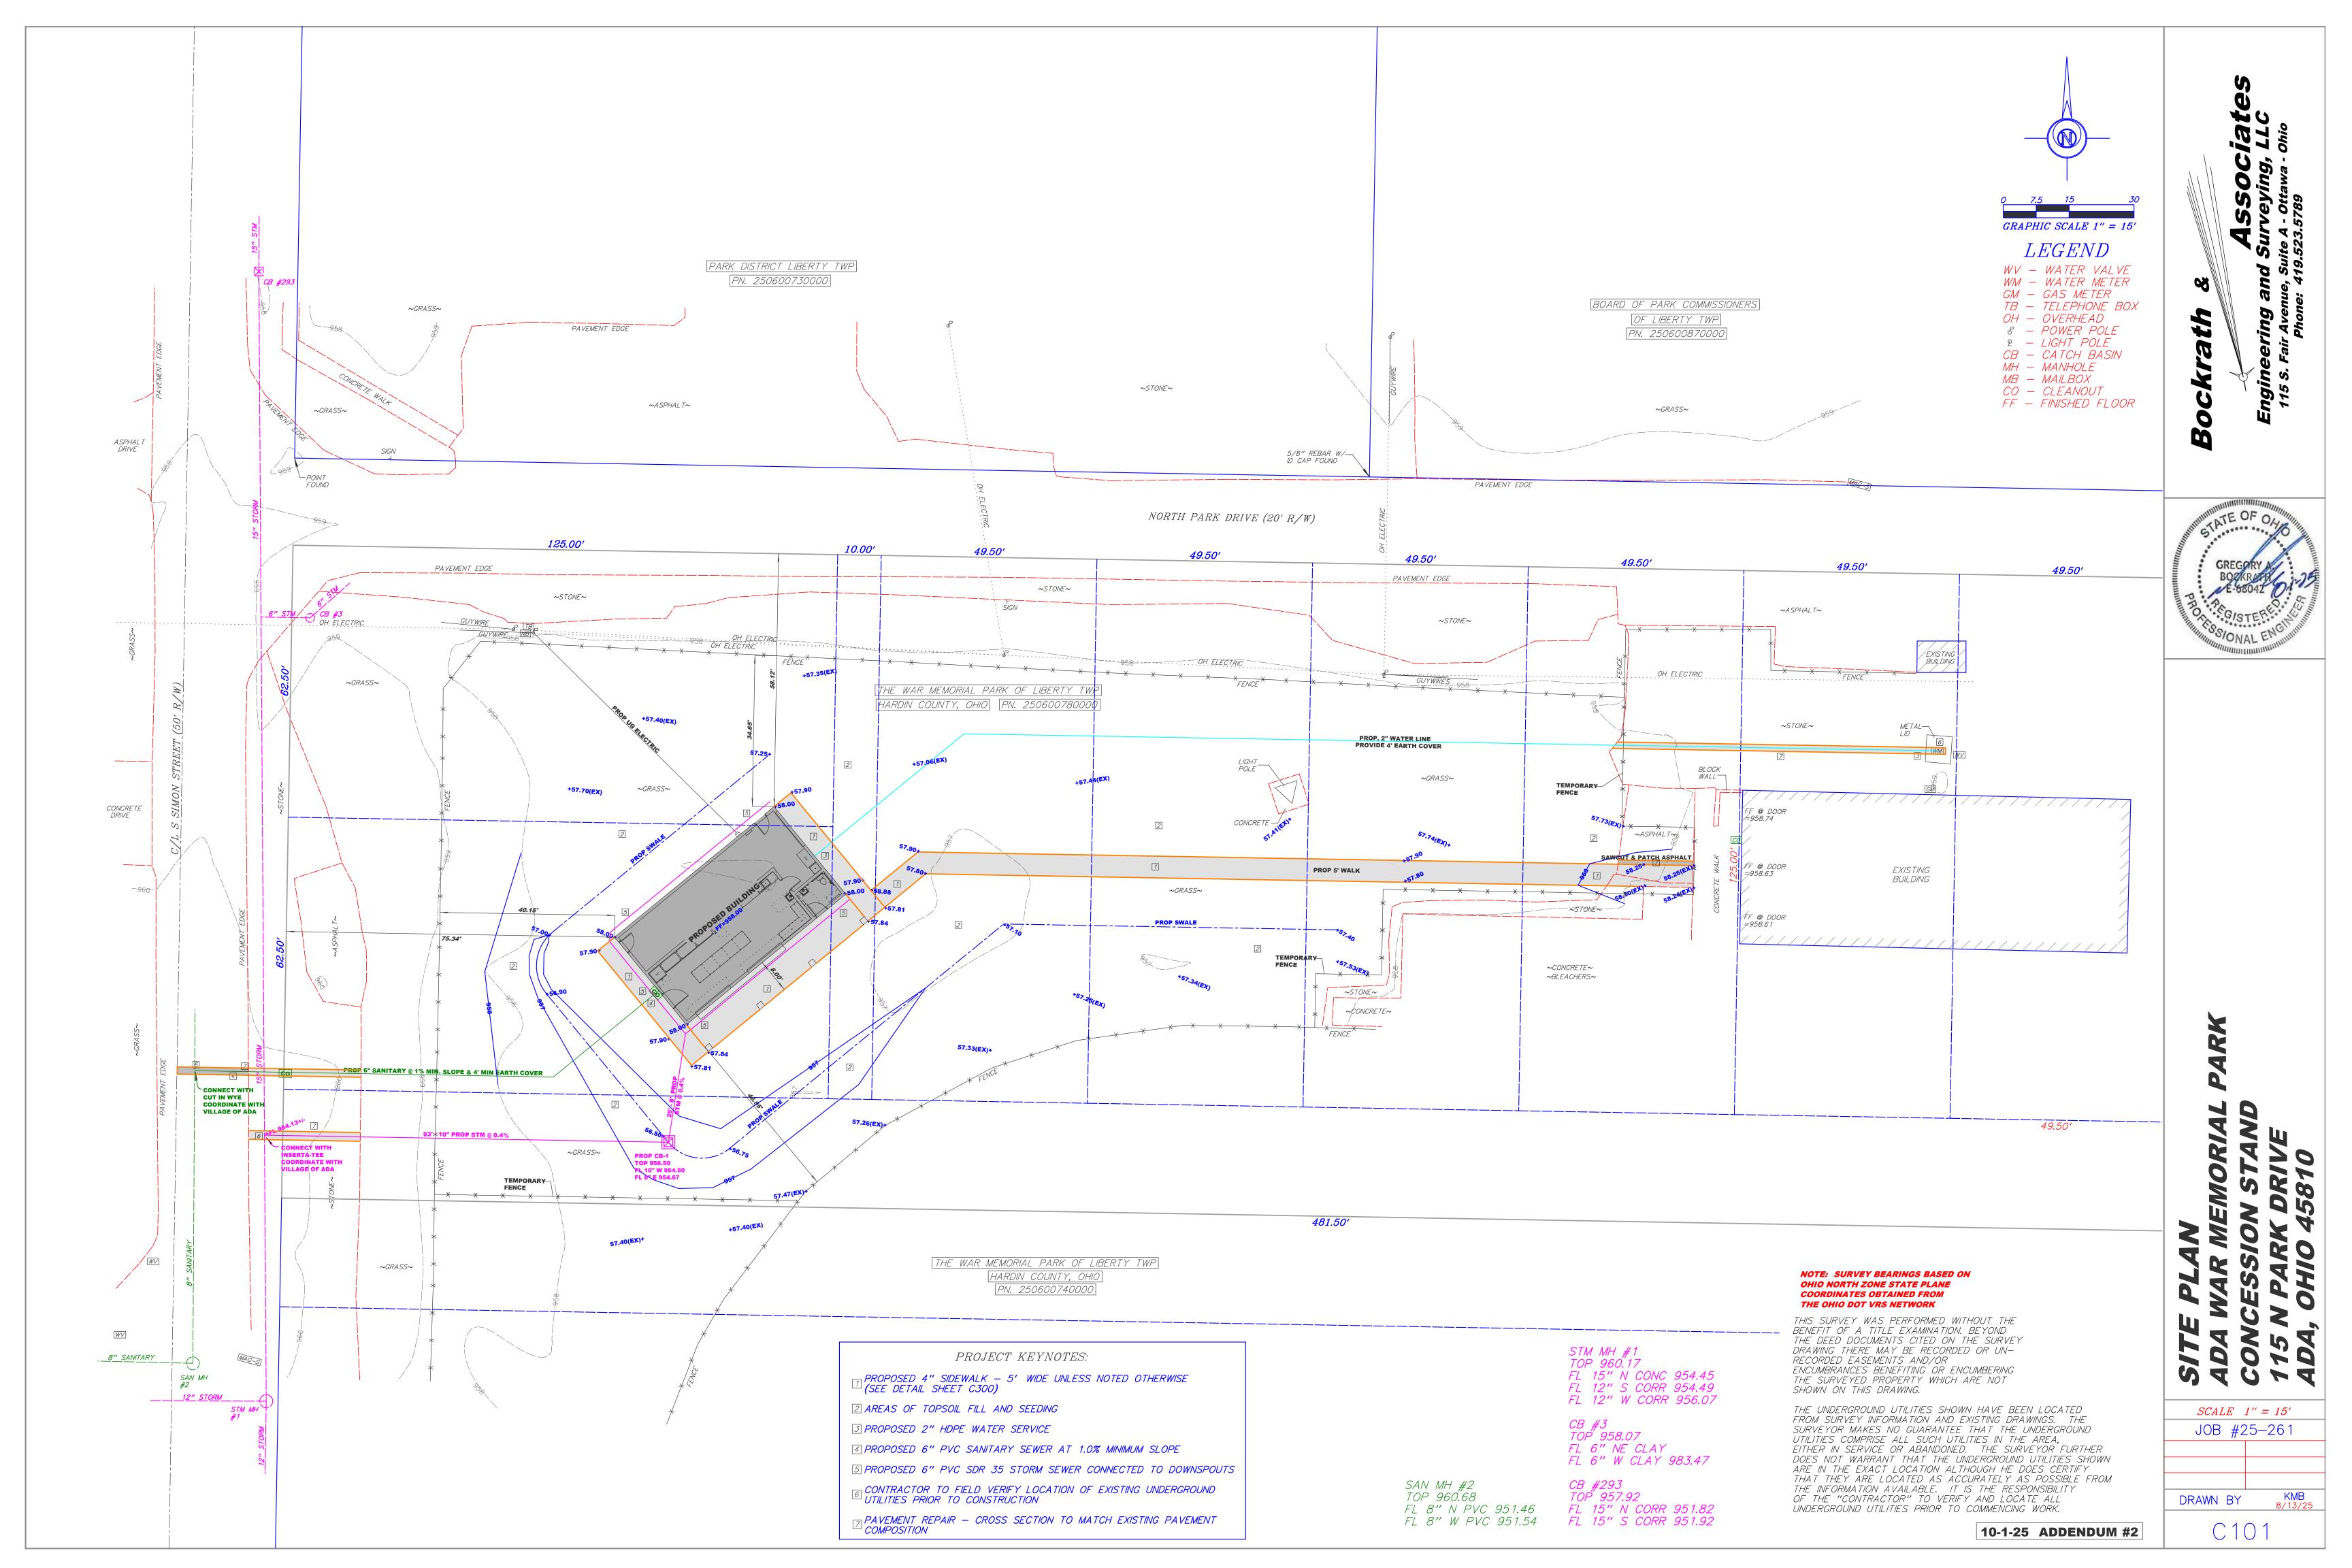

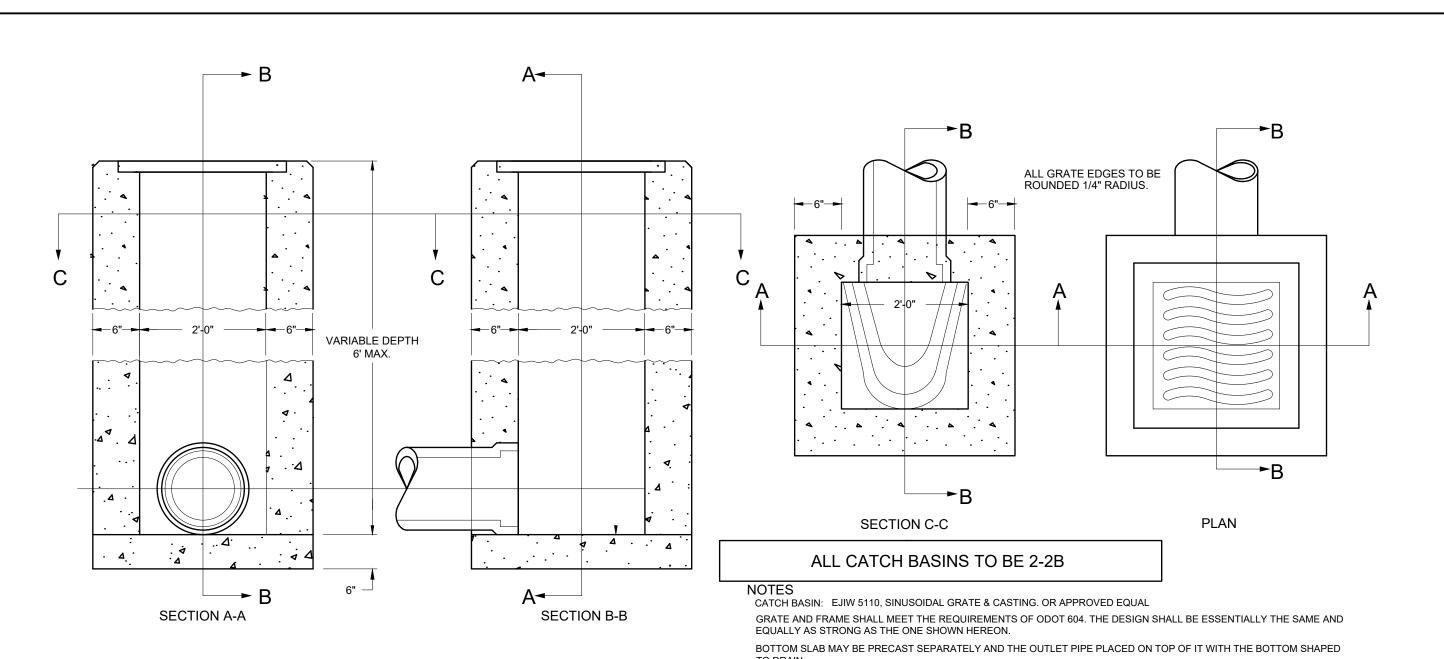


CONTRACTOR MAY USE PRECAST CATCH BASINS WITH KNOCK-OUT PANELS.

## CATCH BASIN 2-2-B

6" CONC. UNDER PUBLIC STREET

PIPE, DIAM. VARIES

TRENCH DETAILS

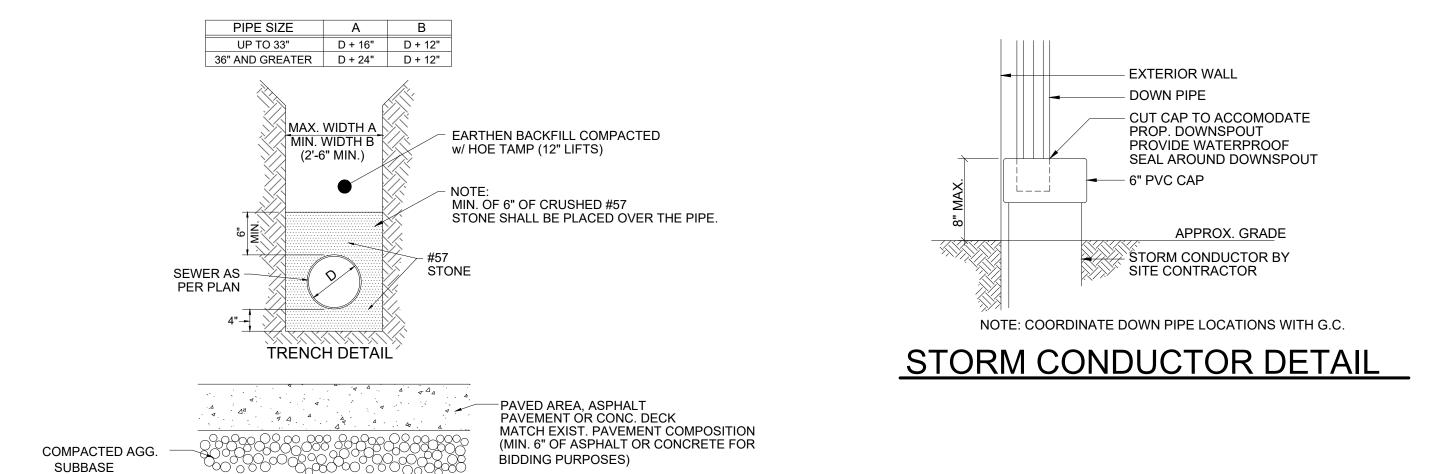

GRANULAR BACKFILL #411 CRUSHED STONE


PIPE SHALL BE LAID ON 4" MIN. OF #57 CRUSHED STONE

STONE


PAVED AREA TRENCH DETAIL (EXTENDING 5' BEYOND PAVEMENT)


CONCRETE WALKS, DRIVES AND CURB RAMPS SHALL BE REINFORCED AND DOWELED INTO THE

TO CLARIFY, THIS APPLIES TO SIDEWALKS, DRIVE APRONS AND CURB RAMPS. THE REINFORCING SHALL BE A #4 REBAR MAT IN THE CENTER OF THE CAST-IN-PLACE SLAB AT MAXIMUM 4 FOOT ON CENTER AND ALSO THE DOWELS SHALL BE AT MAXIMUM 4 FOOT SPACING. THE DOWELS ALSO SHALL BE #4 REBAR AND CAN BE DRILLED INTO THE CURB, SIDEWALK, DRIVE, ETC.

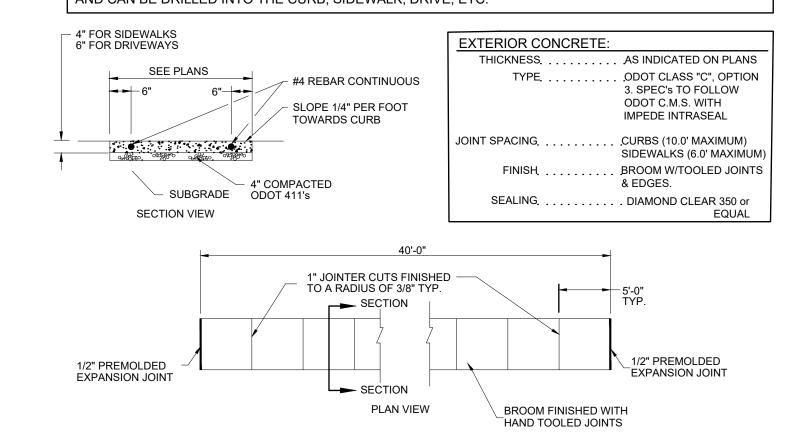

CONCRETE WALK DETAIL

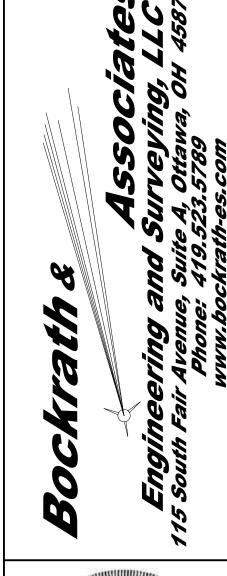

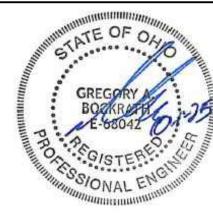


SITE DETAILS & NOTES
ADA WAR MEMORIAL PA
CONCESSTION STAND
115 N PARK DRIVE
ADA, OHIO 45810

REVISED

REVIEWED BY: GAB 9-17-25 DESIGNED BY: KMB 9-17-25 JOB NUMBER: 25-261

C300

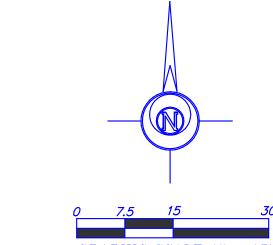


GRAPHIC SCALE 1" = 15'

LEGEND

WM - WATER METER
WF - WATER FOUNTAIN
EB - ELECTRIC BOX
EV - ELECTRIC VAULT
EC - ELECTRIC CONDUIT

2 - LIGHT POLE
CB - CATCH BASIN
MH - MANHOLE
FF - FINISHED FLOOR



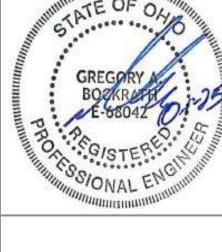

SCALE 1" = 15' JOB #25-261

DRAWN BY

10-1-25 ADDENDUM #2

NOTE: SURVEY BEARINGS BASED ON OHIO NORTH ZONE STATE PLANE COORDINATES OBTAINED FROM THE OHIO DOT VRS NETWORK

THIS SURVEY WAS PERFORMED WITHOUT THE

THIS SURVEY WAS PERFORMED WITHOUT THE BENEFIT OF A TITLE EXAMINATION. BEYOND THE DEED DOCUMENTS CITED ON THE SURVEY DRAWING THERE MAY BE RECORDED OR UN-RECORDED EASEMENTS AND/OR ENCUMBRANCES BENEFITING OR ENCUMBERING THE SURVEYED PROPERTY WHICH ARE NOT SHOWN ON THIS DRAWING.

THE UNDERGROUND UTILITIES SHOWN HAVE BEEN LOCATED FROM SURVEY INFORMATION AND EXISTING DRAWINGS. THE SURVEYOR MAKES NO GUARANTEE THAT THE UNDERGROUND

UTILITIES COMPRISE ALL SUCH UTILITIES IN THE AREA,
EITHER IN SERVICE OR ABANDONED. THE SURVEYOR FURTHER
DOES NOT WARRANT THAT THE UNDERGROUND UTILITIES SHOWN

ARE IN THE EXACT LOCATION ALTHOUGH HE DOES CERTIFY
THAT THEY ARE LOCATED AS ACCURATELY AS POSSIBLE FROM
THE INFORMATION AVAILABLE. IT IS THE RESPONSIBILITY
OF THE "CONTRACTOR" TO VERIFY AND LOCATE ALL
UNDERGROUND UTILITIES PRIOR TO COMMENCING WORK.


~ASPHALT MULTI-USE PATH~ 95t~GRASS~ TO REMAIN FF @ GARAGE / DOOR=953.08 EXISTING BUILDING TO BE REMOVED

BY OWNER EXISTING BUILDING EXISTING BUILDING FF = 953.83 BOARD OF PARK COMMISSIONERS OF LIBERTY TWP
PN. 252100010000 — CONCRETE CONCRETE ~GRASS~ ~GRASS~ ~ASPHALT MULTI-USE PATH~ 

PAVEMENT EDGE


~STONE~

~ASPHALT MULTI-USE PATH~

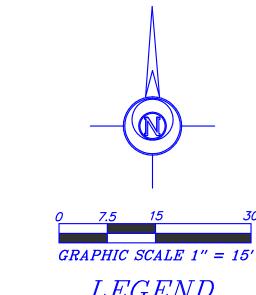

LEGEND

WM - WATER METER
WF - WATER FOUNTAIN
EB - ELECTRIC BOX
EV - ELECTRIC VAULT
EC - ELECTRIC CONDUIT 2 — LIGHT POLE CB — CATCH BASIN MH — MANHOLE FF — FINISHED FLOOR

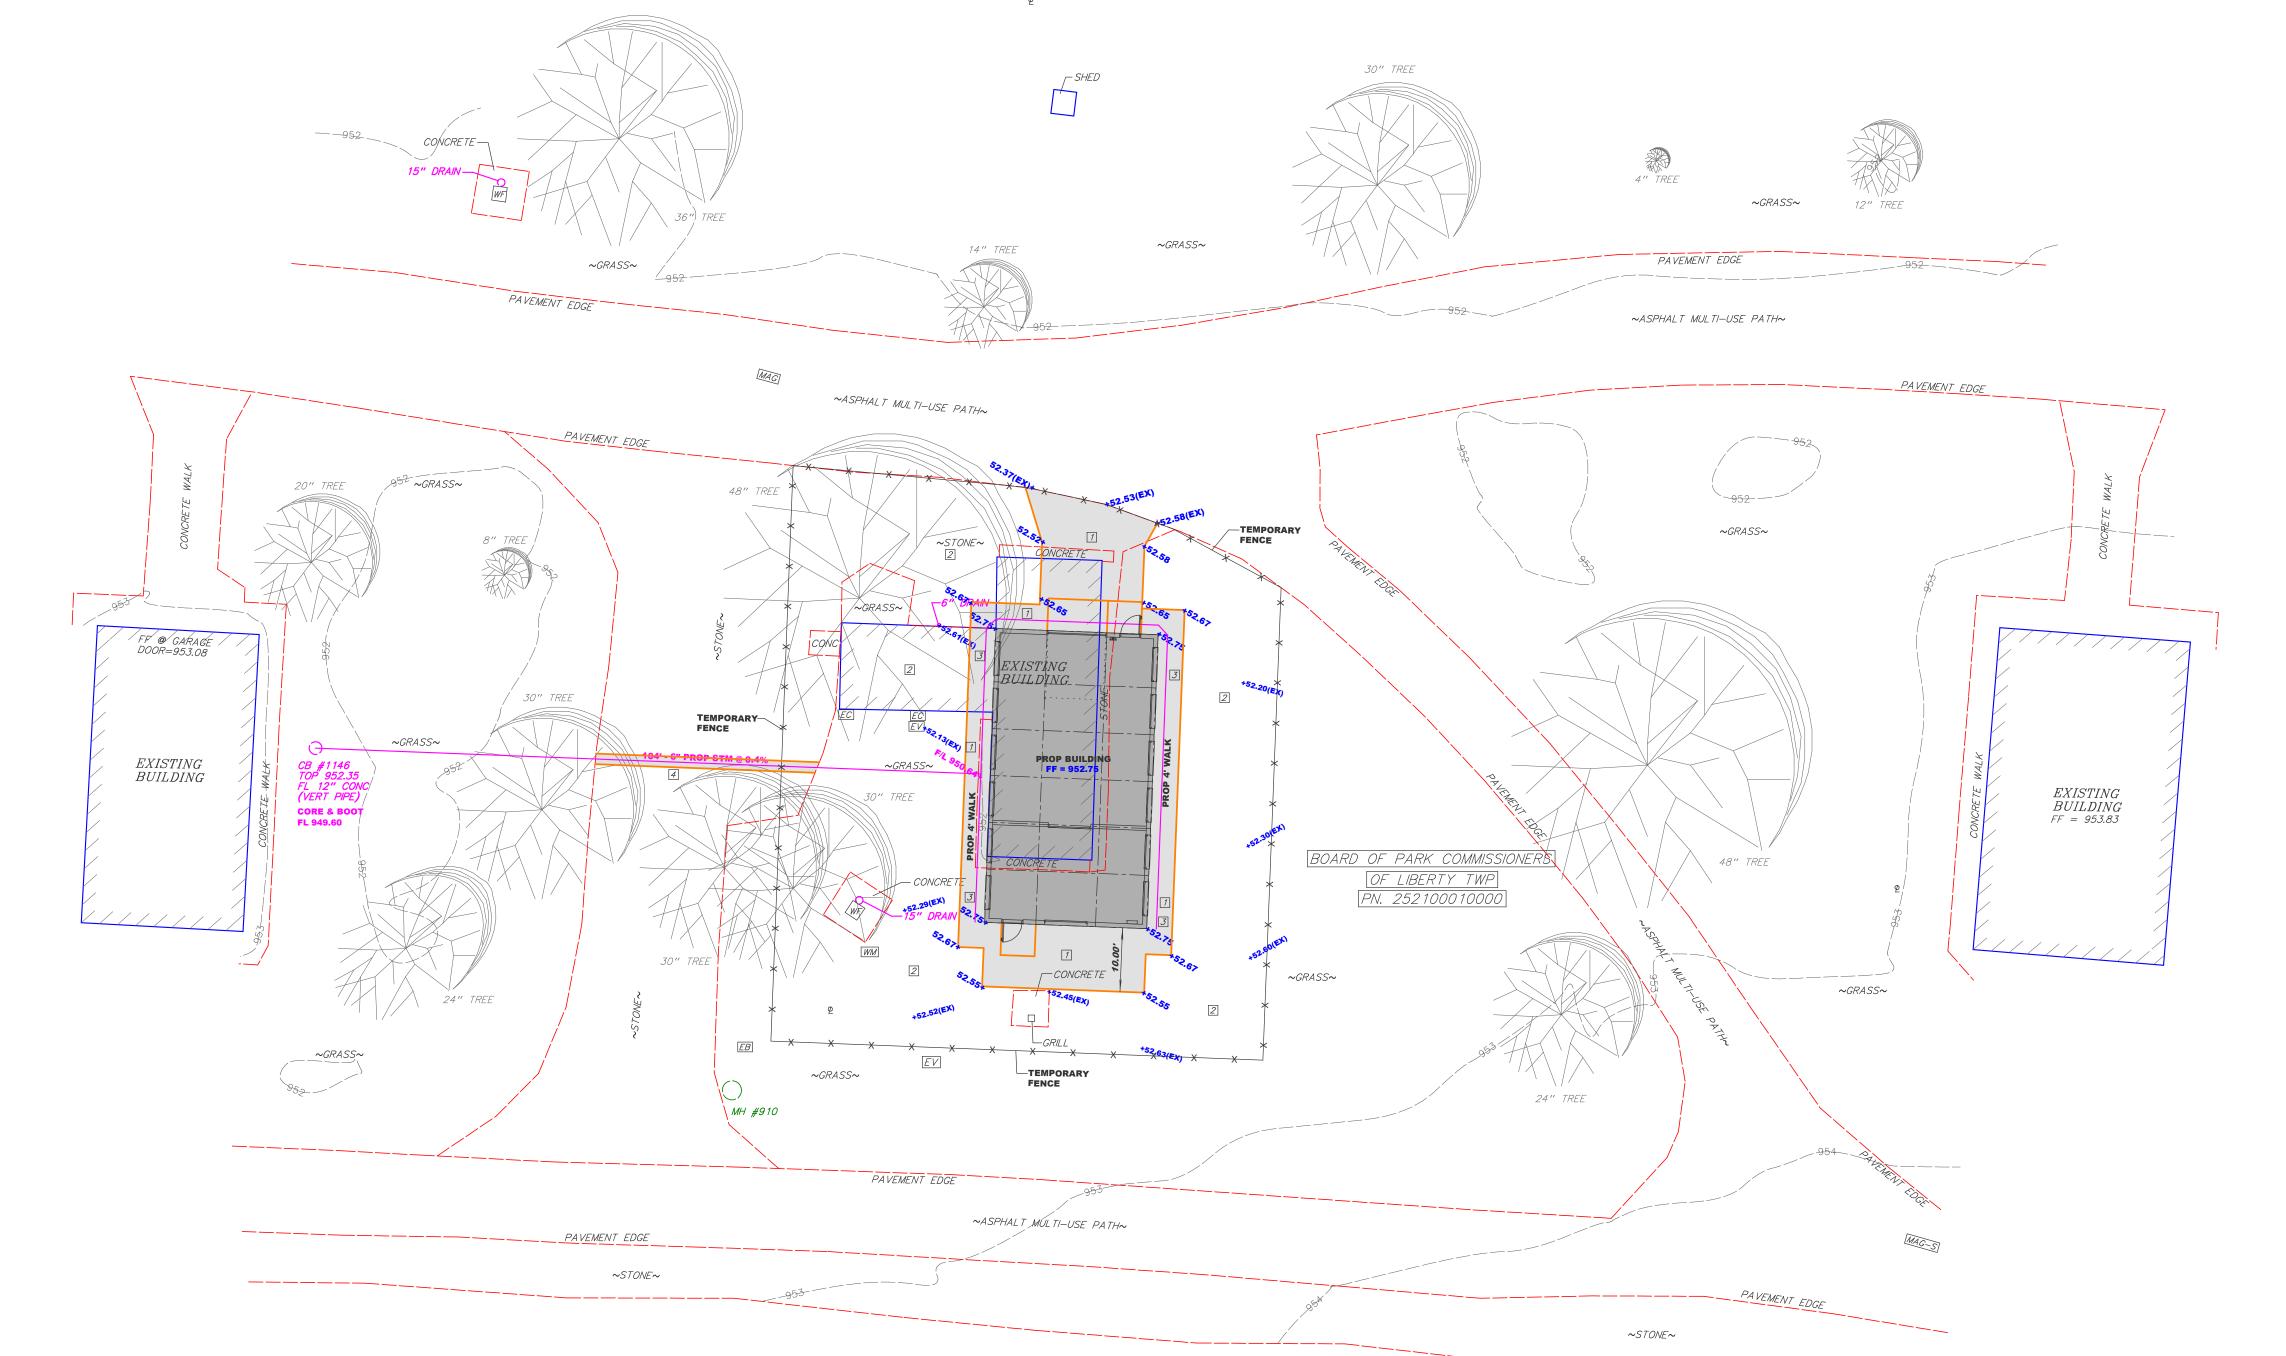

PROJECT KEYNOTES:

PROPOSED 4" SIDEWALK — 4' WIDE UNLESS NOTED OTHERWISE (SEE DETAIL SHEET C300)

2 AREAS OF TOPSOIL FILL AND SEEDING

3 PROPOSED 6" PVC SDR 35 STORM SEWER CONNECTED TO DOWNSPOUTS

STONE REPAIR - CROSS SECTION TO MATCH EXISTING PAVEMENT COMPOSITION

NOTE: SURVEY BEARINGS BASED ON OHIO NORTH ZONE STATE PLANE COORDINATES OBTAINED FROM THE OHIO DOT VRS NETWORK

THIS SURVEY WAS PERFORMED WITHOUT THE BENEFIT OF A TITLE EXAMINATION. BEYOND THE DEED DOCUMENTS CITED ON THE SURVEY DRAWING THERE MAY BE RECORDED OR UN-RECORDED EASEMENTS AND/OR ENCUMBRANCES BENEFITING OR ENCUMBERING THE SURVEYED PROPERTY WHICH ARE NOT SHOWN ON THIS DRAWING.


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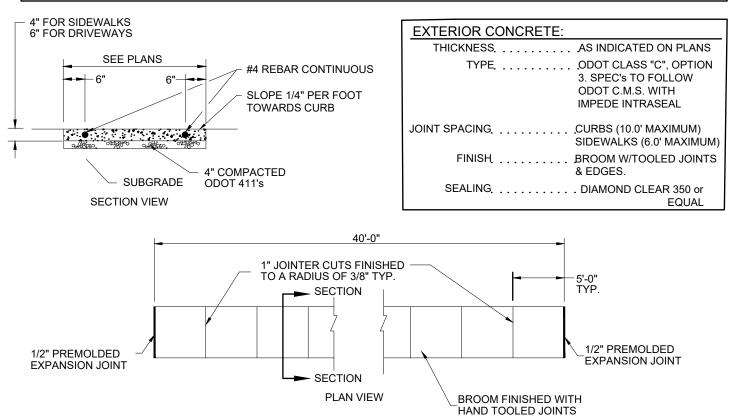
DRAWN BY

10-1-25 ADDENDUM #2

SCALE 1" = 15'

JOB #25-261




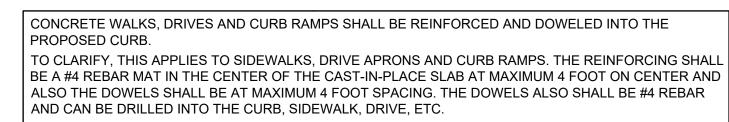

## EXTERIOR WALL DOWN PIPE CUT CAP TO ACCOMODATE PROP. DOWNSPOUT PROVIDE WATERPROOF SEAL AROUND DOWNSPOUT 6" PVC CAP APPROX. GRADE STORM CONDUCTOR BY SITE CONTRACTOR NOTE: COORDINATE DOWN PIPE LOCATIONS WITH G.C.

## STORM CONDUCTOR DETAIL

## CONCRETE WALK DETAIL

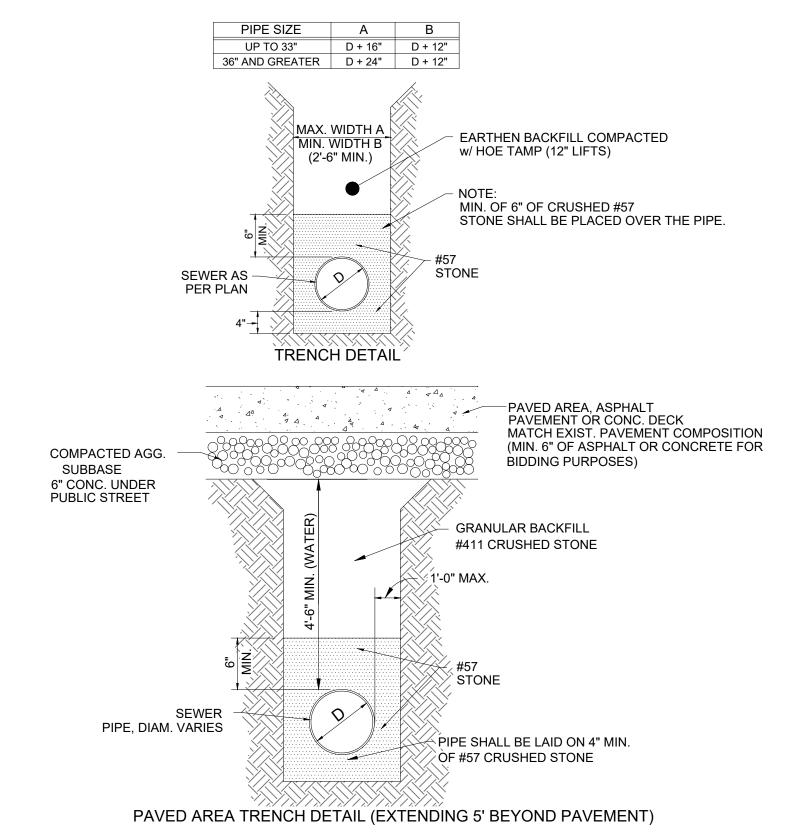

TRENCH DETAILS

GREGORY ABOOKRAFE
BOOKRAFE
BOOKRAFE
ITE DETAILS & NOTES


NDA WAR MEMORIAL PARK

REVISED

REVIEWED BY: GAB 9-17-25 DESIGNED BY: KMB 9-17-25 JOB NUMBER: 25-261

C300

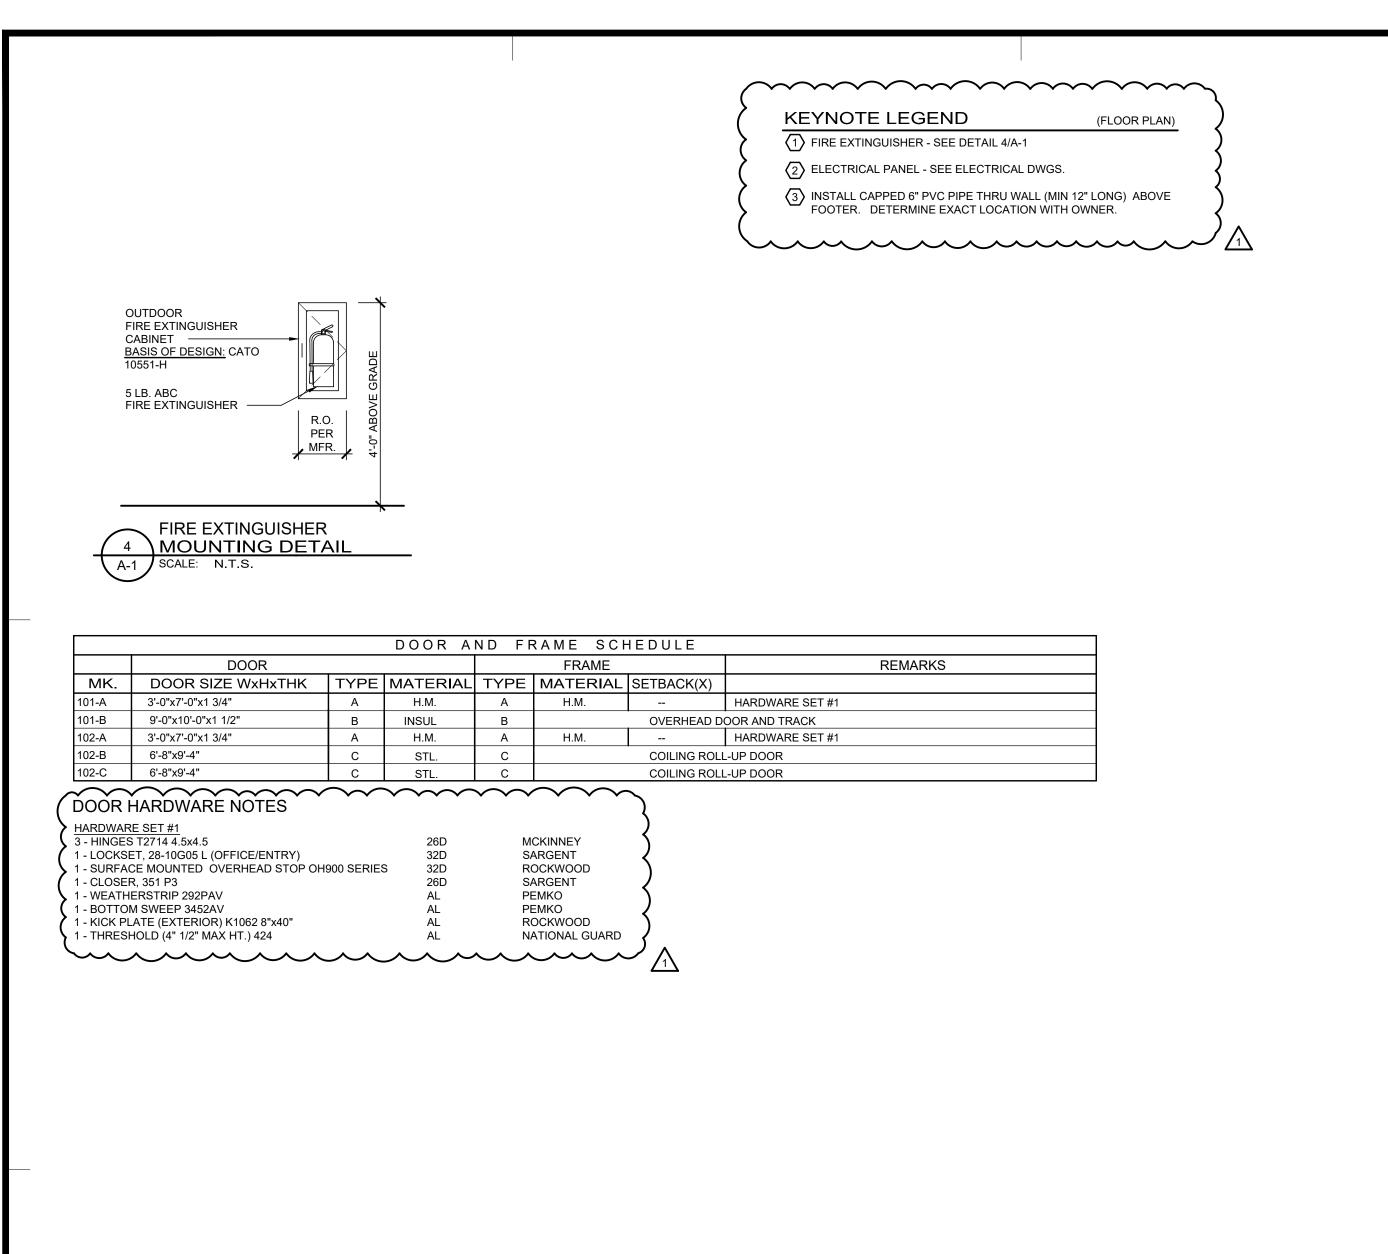

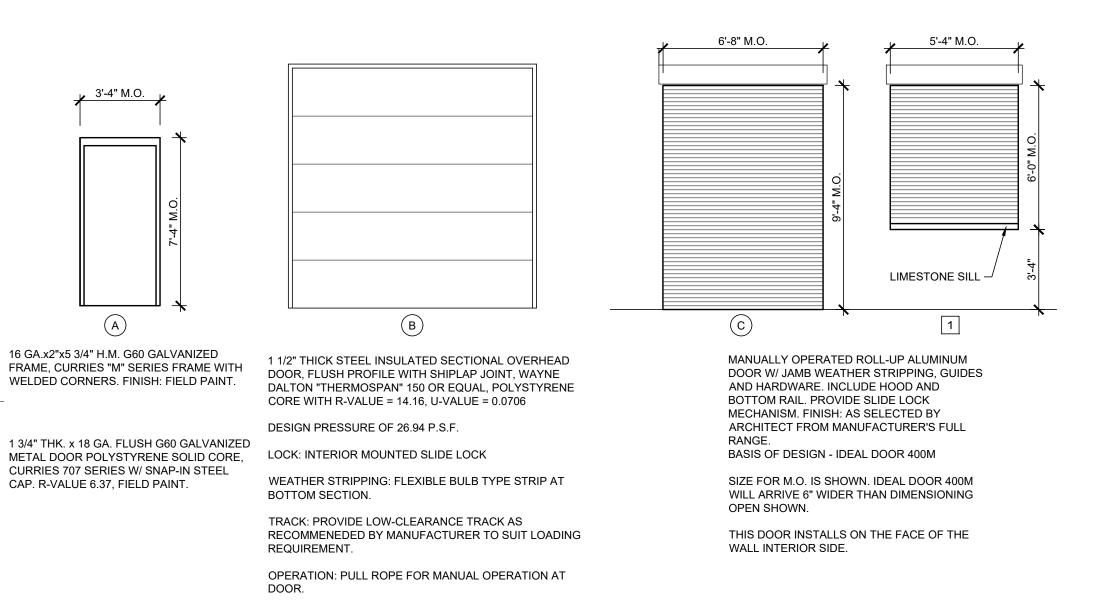



WARRANTY: TEN (10) YEAR FROM CRACKING, SPLITTING OR DETERIORATION DUE TO RUST. SEVEN (7) YEARS FROM SEPARATION OF POLYSTYRENE FROM THE STEEL

DOOR FINISH: VERIFY COLOR AND FINISH AS SELECTED FROM DOOR MANUFACTURER'S STANDARD COLORS WITH

SKIN OF THE PANEL.

DOOR & WINDOW TYPE

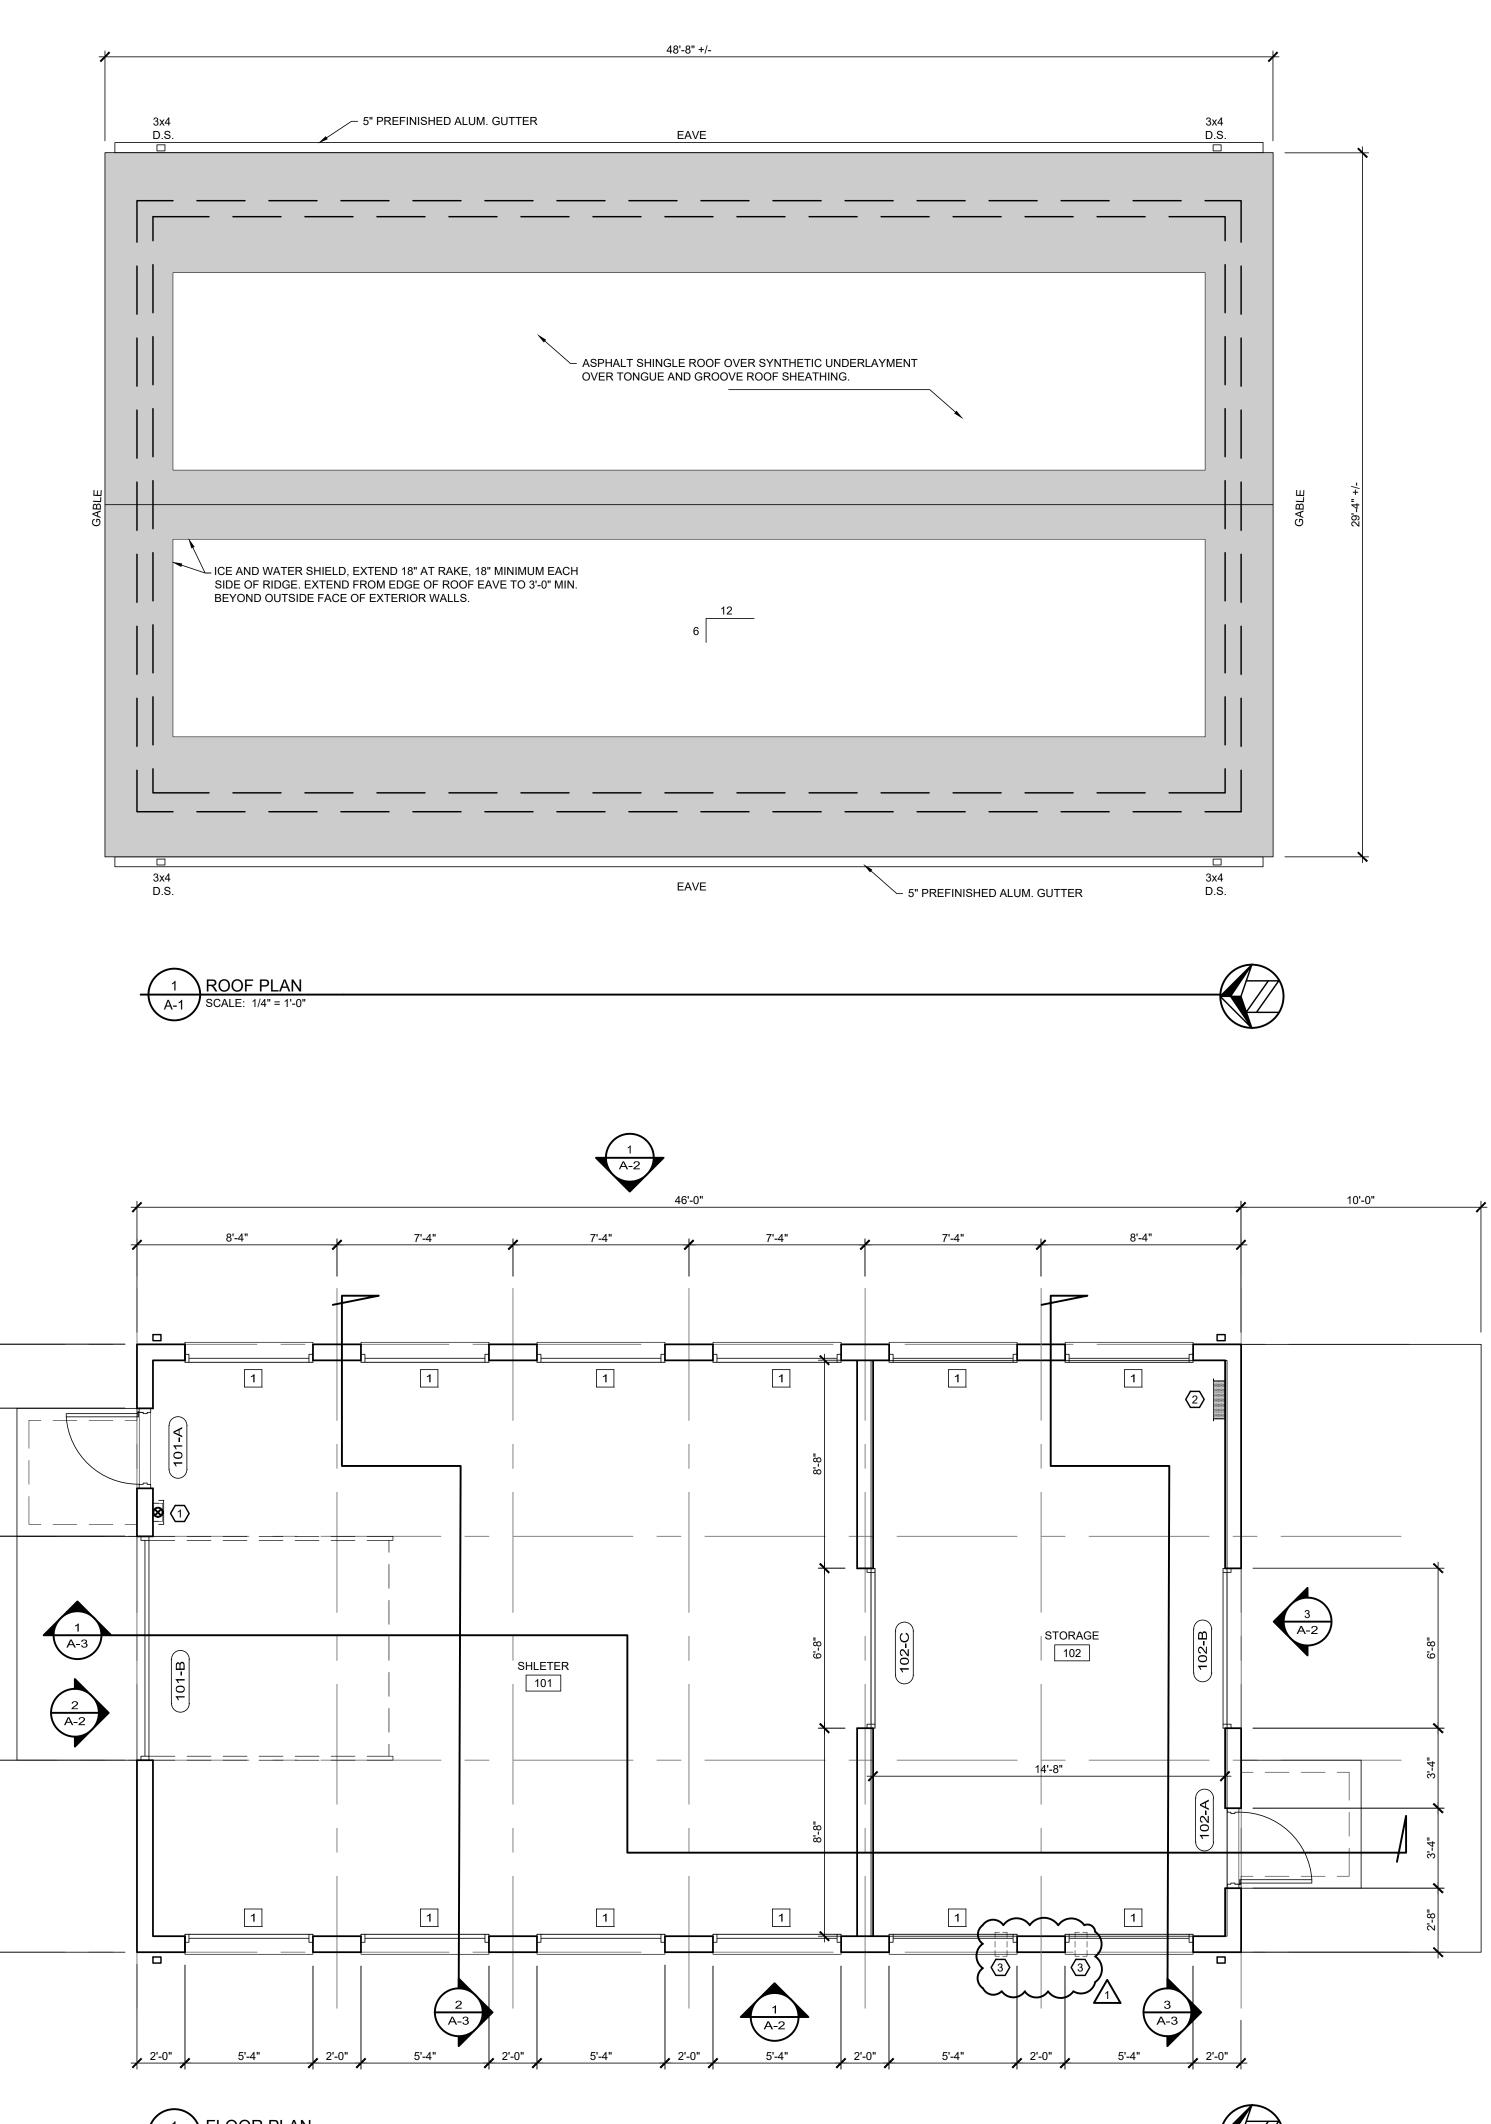

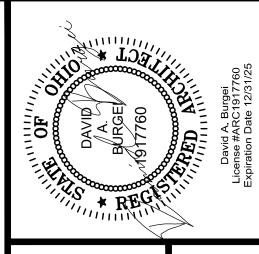

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R MEMORIA DRIV WAR

 Property

**ENCLO** 

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FLOOR PLAN, ROOF PLAN,

DOOR & WINDOW TYPES **ISSUED DATE** 05/19/2025 MEETING


06/16/2025 MEETING 07/21/2025 MEETING 08/18/2025 MEETING 09/09/2025 PERMITS / BIDDING 09/29/2025 ADDENDUM #2


DRAWN BY: DATE:

SHEET SIZE: 24x36 JOB NO. 41-3097-25 SHEET

A-1

07-25

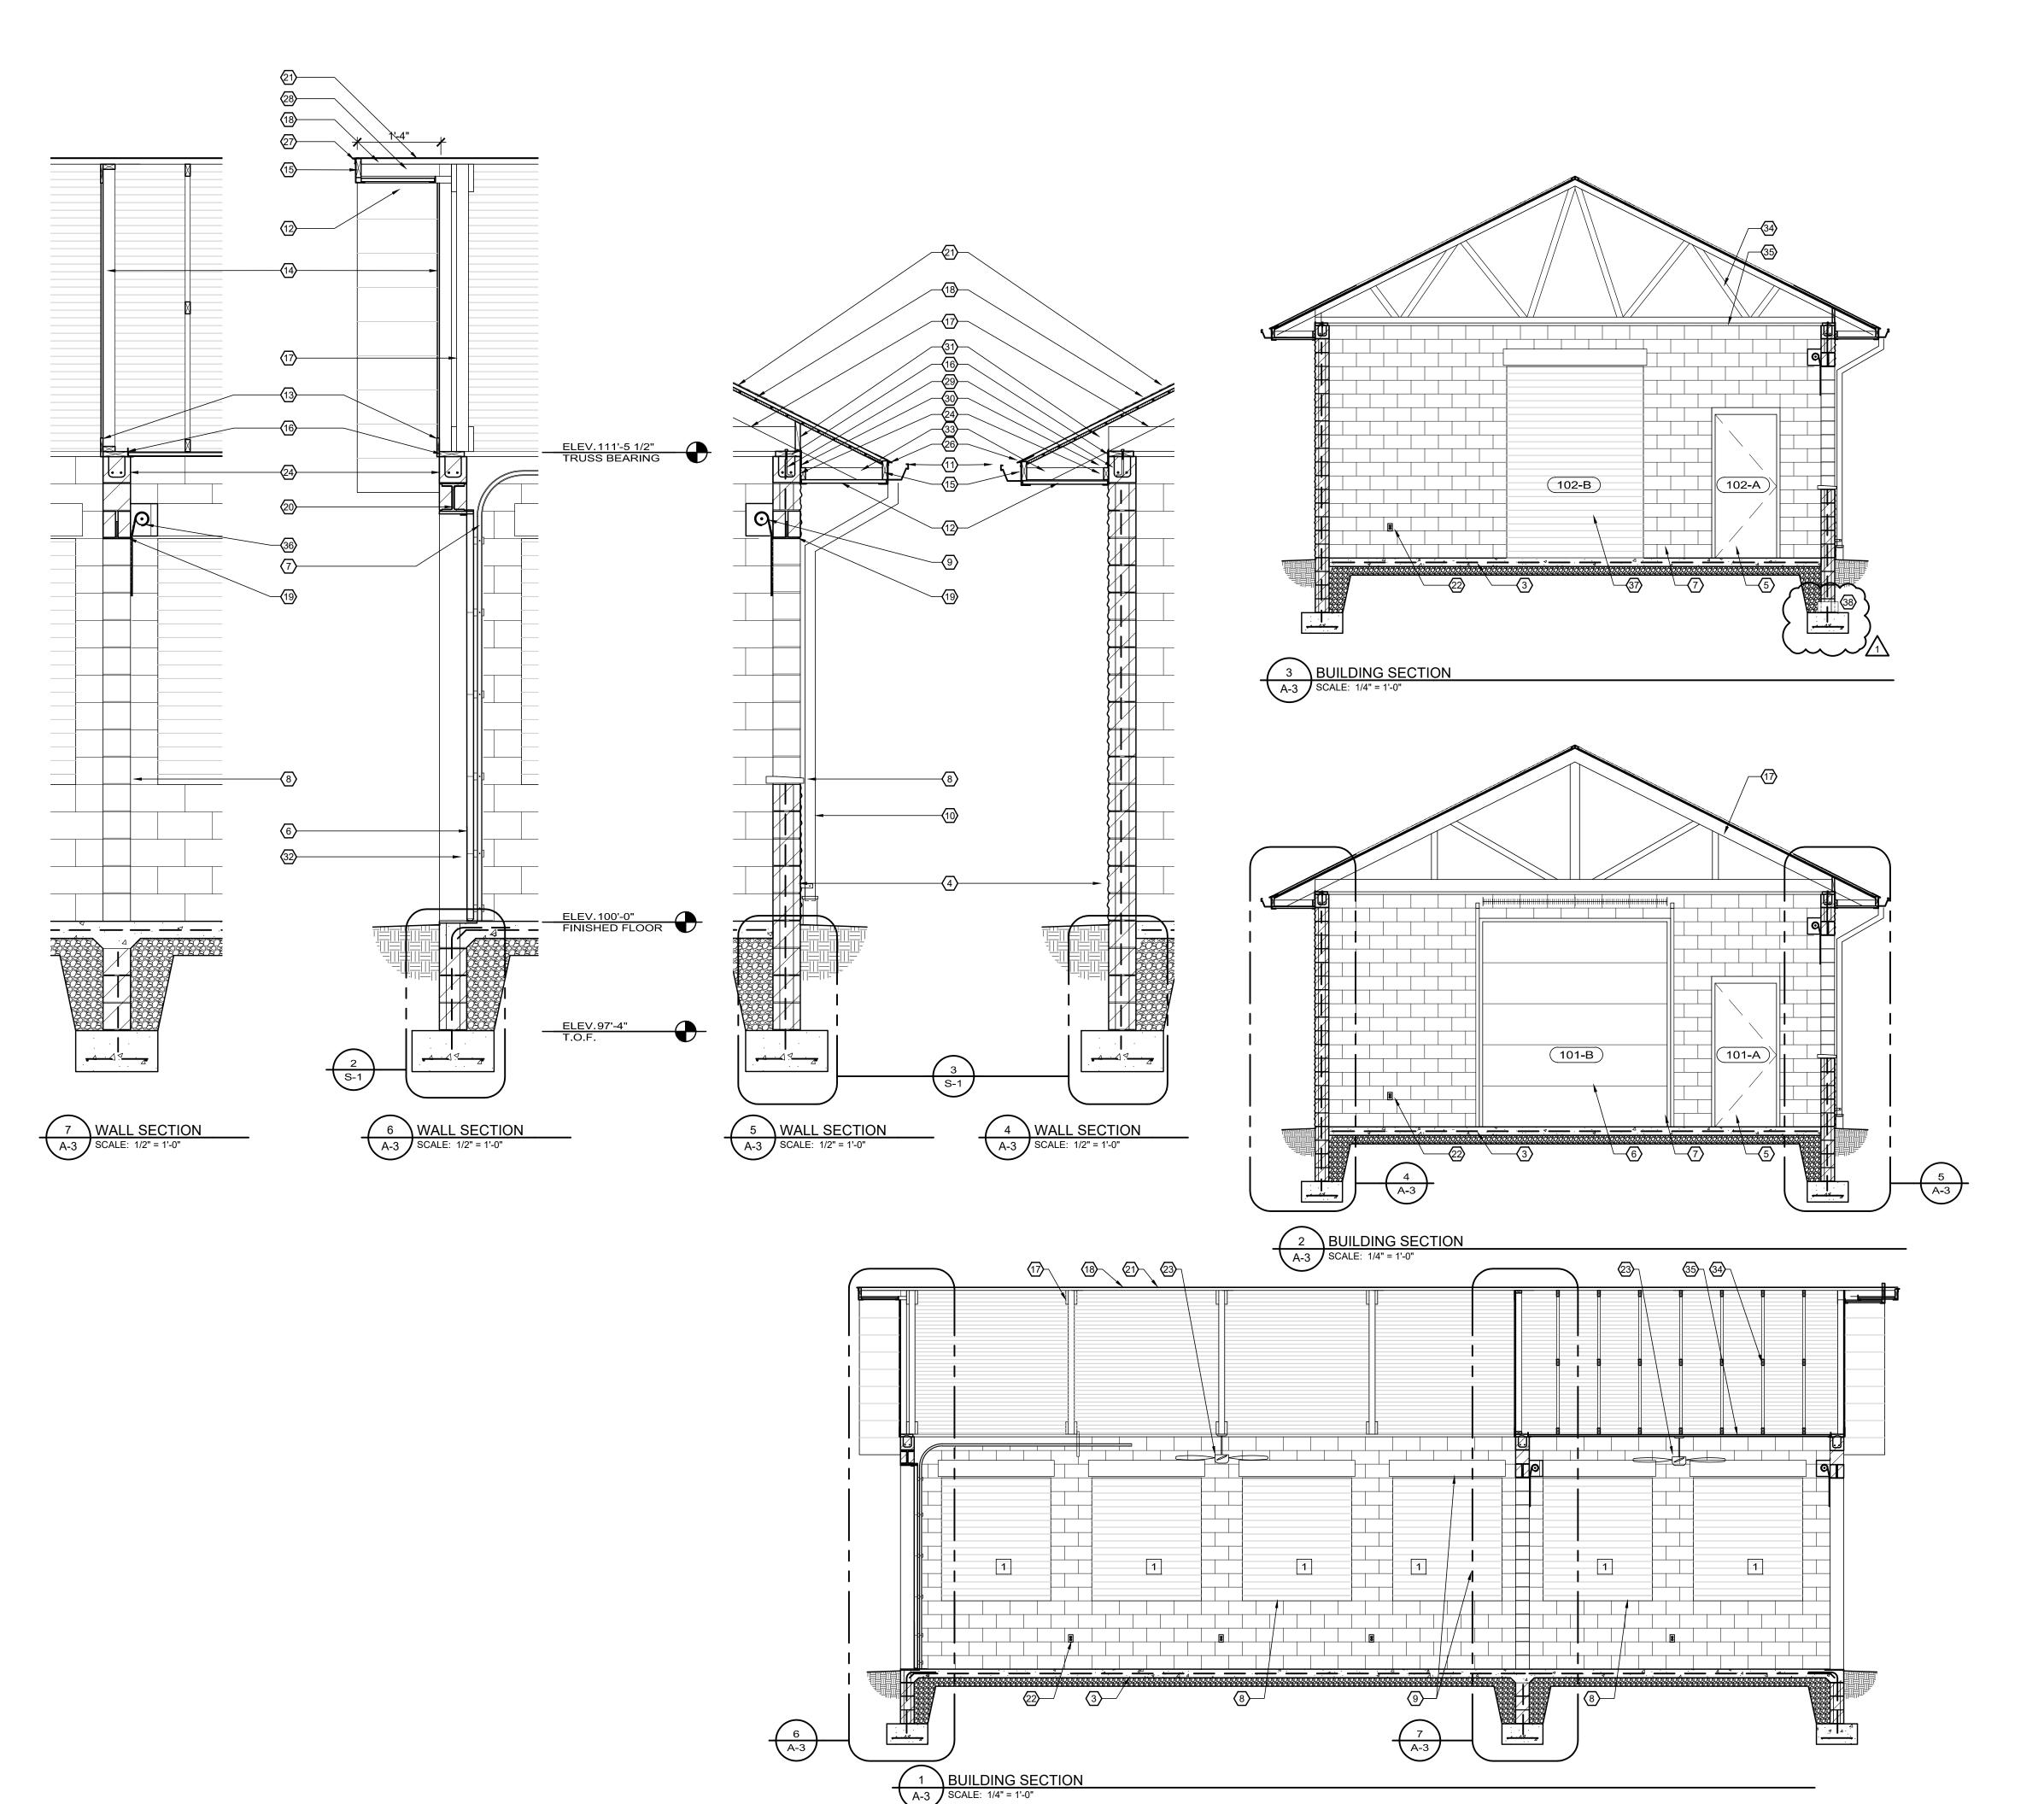

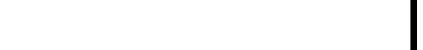

- 8" CMU WALL. SMOOTH FACE INTERIOR. SPLIT FACE EXTERIOR. SASH BLOCKS ON DOOR AND WINDOW OPENINGS. BASIS OF DESIGN: TRI-COUNTY BLOCK AND BRICK. COLOR: LIMESTONE. MORTAR COLOR: O BE SELECTED BY ARCHITECT FROM THE
- (5) 3'Wx7'H HOLLOW METAL DOOR AND FRAME (WITH MASONRY
- (7) OVERHEAD DOOR TRACK.

- (11) 5" PREFINISHED ALUMINUM GUTTER, DETAIL 7/A-2.

- (2) L5 STEEL ANGLE HEADER FOR ROLL-UP DOOR OPENING w/ 4" BLOCK CUT TO FIT AROUND EITHER SIDE OF LINTEL.
- W8 STEEL BEAM HEADER FOR GARAGE DOOR OPENING w/ 4" BLOCK CUT TO FIT AROUND EITHER SIDE OF LINTEL.
- 21) ASPHALT SHINGLE OVER SYNTHETIC UNDERLAYMENT. BASIS OF
- (22) GFCI DUPLEX ELECTRICAL RECEPTACLE.
- 23 CEILING FAN SEE ELECTRICAL DRAWINGS
- 8" BOND BEAM AT TOP OF MASONRY WALL TO MATCH
- 27 PREFINISHED METAL DRIP EDGE @ GABLES
- (28) 2x4 OUTRIGGERS 16" O.C.
- 29) 1/2" DIA.x8" LONG ANCHOR BOLTS w/ HOOK @ 32" O.C.
- SIMPSON STRONT TIE MTSM 16"x16 GA. TIE DOWN TRAP AT EACH TRUSS.
- 33 SOFFIT FRAMING 24" O.C.
- 35) METAL LINER PANEL CEILING
- (37) 6'-8"Wx9'-4"H ROLLING DOOR. ABOVE FOOTER. DETERMINE EXACT LOCATION WITH OWNER.




1 LIGHT FIXTURE - SEE ELECTRICAL DRAWINGS.

- 2 NOT USED.
- 5" THICK REINFORCED CONCRETE FLOOR OVER COMPACTED ENGINEERED STONE FILL.
- MANUFACTURERS STANDARD RANGE.
- 6 9'Wx10'H INSULATED OVERHEAD DOOR.
- 8 CUT LIMESTONE SILL. SEE DETAIL 4/A-2.
- 9 5'-4"Wx6'H ROLLING COUNTER SHUTTER.
- 3x4 ALUMINUM DOWNSPOUT w/ DOWNSPOUT BRACKET. SEE DETAIL 5/A-2.
- (12) METAL SOFFIT PANEL, DETAIL 8/A-2.
- 13 1x6 RED CEDAR TRIM BOARD. SMOOTH FACE.
- (14) 1x8 REVERSIBLE TONGUE AND GROOVE CEDAR SELECT TIGHT KNOT SIDING (SMOOTH FACE OUT) OVER WEATHER RESISTANT BARRIER OVER 7/16" OSB SHEATHING.
- 2x6 FRIEZE/EAVE BOARD WRAP w/ PREFINISHED METAL w/ HEMMED EDGES AS REQ'D TO RECEIVE SOFFIT
- 16) PRESSURE TREATED 2x8 PLATE FOR TRUSS BEARING.
- (17) CUSTOM MANUFACTURED WOOD TRUSS. SEE DETAIL 2/S-2.
- (18) 2x6 TONGUE AND GROOVE ROOF DECK.

- DESIGN: OWENS CORNING DURATION 50 YEAR SHINGLES.

- DECORATIVE BLOCK. SMOOTH INTERIOR. SPLIT FACE EXTERIOR ON GABLE ENDS, SMOOTH FACE ON SOFFIT SIDES.
- 25) 2x4 FRAMED GABLE WALL, STUDS 16" O.C.
- 26 PREFINISHED METAL DRIP EDGE AT EAVES

- 2x10 BLOCKING, CUT DOWN TO FIT BETWEEN TRUSSES.
- (32) O.H.D. VINYL SEAL
- WOOD TRUSSES 24" O.C. SEE SHEET SR101.
- (36) 6'-8"Wx6'H ROLLING COUNTER SHUTTER.
- (38) INSTALL (2) CAPPED 6" PVC PIPE THRU WALL (MIN 12" LONG)  $\sim\sim\sim\sim\sim\sim\sim\sim$

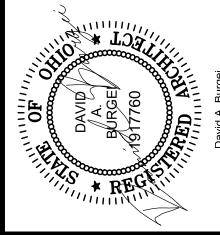

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**EXTERIOR ELEVATIONS** 


**BUILDING SECTIONS** 


**ISSUED DATE** 05/19/2025 MEETING 06/16/2025 MEETING 07/21/2025 MEETING 08/18/2025 MEETING 09/09/2025 PERMITS / BIDDING

09/29/2025 ADDENDUM #2

DRAWN BY:	
DATE:	07-25
SHEET SIZE:	24x36
JOB NO.	41-3097-25

SHEET A-3

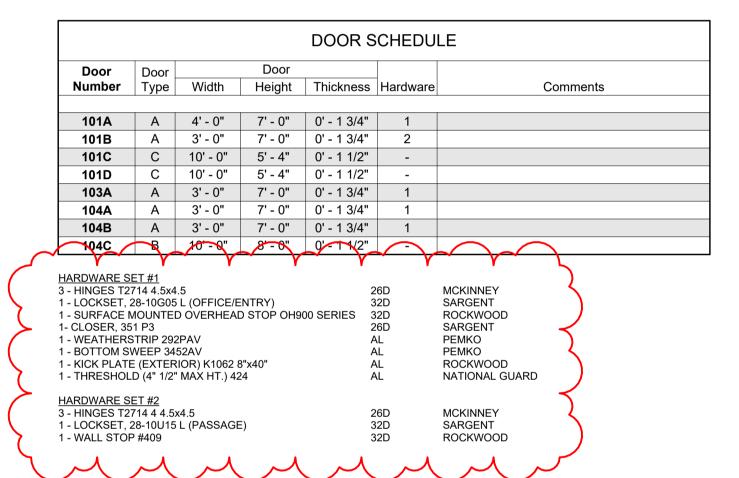

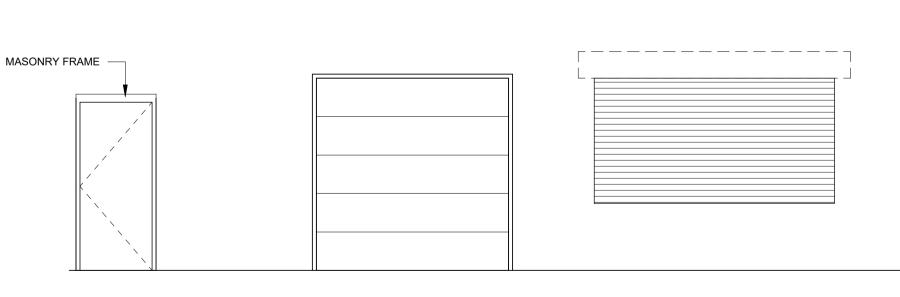

16 GA x 2" HOLLOW METAL FRAME, CURRIES "M" SERIES WELDED CORNER FRAME FINISH: FIELD PAINT 1 3/4" THK X 18 GA. FLUSH G60

GALV. METAL, POLYSTYRENE

SERIES w/ SNAP-IN STEEL CAP.

SOLID CORE, CURIES 707

FIELD PAINT.

1 1/2" THICK STEEL INSULATED SECTIONAL OVERHEAD DOOR, FLUSH PROFILE WITH SHIPLAP JOINT, WAYNE DALTON "THERMOSPAN" 150 OR EQUAL, POLYSTYRENE CORE WITH R-VALUE = 14.16, U-VALUE = 0.0706

DESIGN PRESSURE OF 26.94 P.S.F. LOCK: INTERIOR MOUNTED SLIDE LOCK

WEATHER STRIPPING: FLEXIBLE BULB TYPE STRIP AT BOTTOM SECTION.

TRACK: PROVIDE LOW-CLEARANCE TRACK AS RECOMMENEDED BY MANUFACTURER TO SUIT LOADING

OPERATION: PULL ROPE FOR MANUAL OPERATION AT

WARRANTY: TEN (10) YEAR FROM CRACKING, SPLITTING OR DETERIORATION DUE TO RUST. SEVEN (7) YEARS FROM SEPARATION OF POLYSTYRENE FROM THE STEEL SKIN OF THE PANEL.

DOOR FINISH: VERIFY COLOR AND FINISH AS SELECTED FROM DOOR MANUFACTURER'S STANDARD COLORS WITH


MANUALLY OPERATED ROLL-UP ALUMINUM COUNTER DOOR W/ JAMB WEATHER STRIPPING, GUIDES AND HARDWARE. INCLUDE HOOD AND BOTTOM RAIL. PROVIDE SLIDE LOCK MECHANISM. FINISH: AS SELECTED BY ARCHITECT FROM MANUFACTURER'S FULL COLOR RANGE. BASIS OF DESIGN - IDEAL DOOR 400M


NOTE: WIDTH AND HEIGHT INICATED ON SCHEDULE ARE TO MASONRY OPENING. DOORS MOUNT TO THE INSIDE FACE OF THE WALL AND EXTEND 6" BEYOND THE M.O. OF


2 RESTROOM 103 NORTH ELEV

\ ENLARGED RESTROOM PLAN


A401 SCALE: 3/8" = 1'-0"

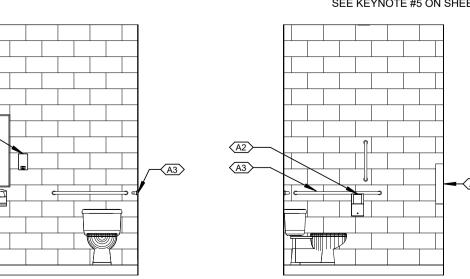

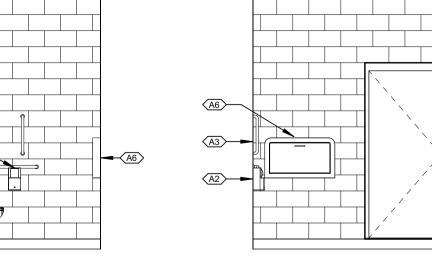


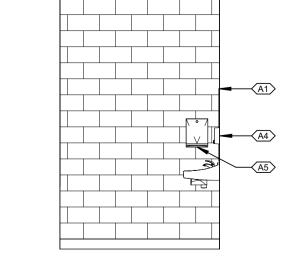


A401 SCALE: 1/4" = 1'-0"

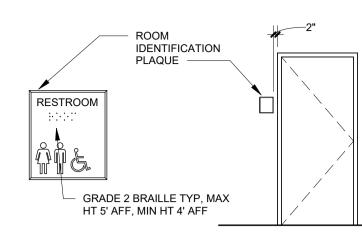

11 ROOM SIGNAGE MOUNTING DETAIL
A401 SCALE: 1/4" = 1'-0"

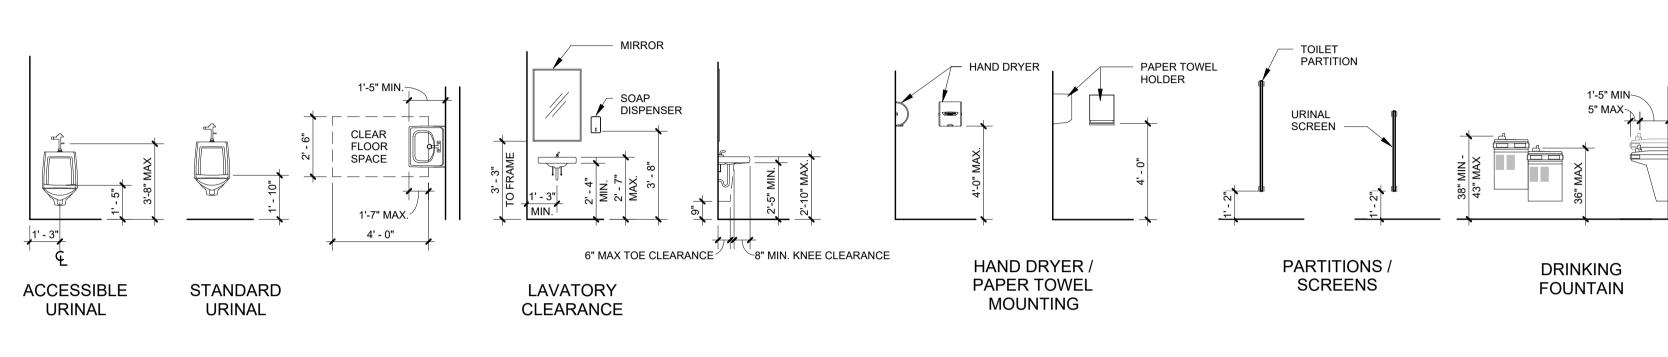

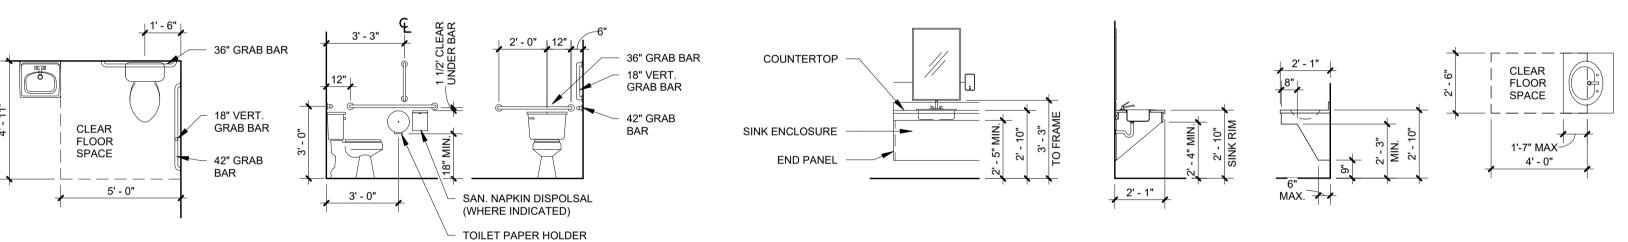


SPACE ACCESSIBILITY & MOUNTING DETAILS PER

10 ICC A117.1 STANDARDS A401 SCALE: 1/4" = 1'-0"

WATER CLOSET -

CLEAR FLOOR

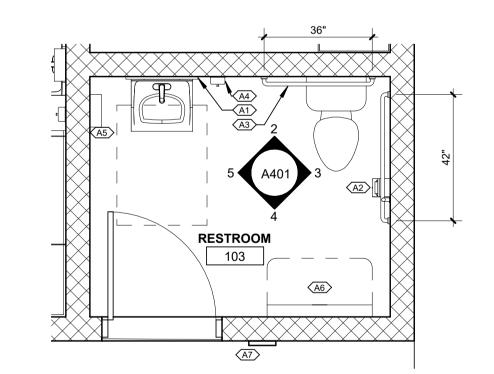

	ACCESSORIES SCHEDULE						
Type Mark	Type Mark DESCRIPTION MFGR. & MODEL						
A1	MIRROR, 24x36	BOBRICK B-165 2436	1				
A2	TOILET PAPER HOLDER	FURNISHED AND INSTALLED BY OWNER	1				
A3	TOILET GRAB BAR SET	BOBRICK B-6806	1				
A4	SOAP DISPENSER	FURNISHED AND INSTALLED BY OWNER	1				
A5	PAPER TOWEL DISPENSER	FURNISHED AND INSTALLED BY OWNER	1				
A6	BABY CHANGING STATION	KOALA BARE KARE HORIZ. CHANGING STATION					
A7	ROOM SIGN "RESTROOM" ACCESSIBLE	ROWMARK "ULTRA MATTES"	2				


COUNTERTOP

LAVATORY

1. SEE ACCESSORY & MOUNTING DETAILS PER ICC A117.1 STANDARDS 10/A401

SEE SIGNAGE DETAIL 11/A401 3. SEE INTERIOR ELEVATION 3/A101 FOR ADDITIONAL PAPER TOWEL AND SOAP DISPENSER LOCATION.

## SEE KEYNOTE #5 ON SHEET A101 FOR DETAILS ON RESTROOM WALL FINISHES

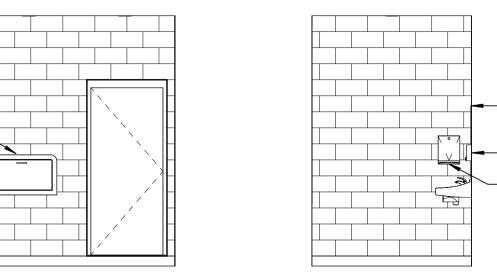

3 RESTROOM 103 EAST ELEV 4 RESTROOM 103 SOUTH ELEV

Group

ON STAND **PARK** MEMORIAL SSI ONCE

DRI 10

I. PARK OH 458′

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**ENLARGED RESTROOM** PLANS, INTERIOR **RESTROOM ELEVATIONS,** MOUNTING DETAILS, DOOR **TYPES & SCHEDULE** 

ICCLIED	Δ.
ISSUED	DΑ

1990ED DATE						
DATE	DESCRIPTION					
07/21/2025	OWNER REVIEW					
08/18/2025	OWNER REVIEW					
09/10/2025	PERMITS / BIDDING					
10/1/2025	ADDENDUM #2					

DRAWN	BY:	DAB
DATE:		
SHEET S	SIZE:	24" x 36"

41-3097-25 JOB NO.

SHEET A401


DOOR TYPES LEGEND SCALE: 1/4" = 1'-0"

GENERAL NOTES

- CONDUITS SHALL BE A MINIMUM OF 1" SCHEDULE 40 PVC, U.N.O., BURIED MINIMUM 30" BELOW GRADE, IN TRAFFIC AREAS, AND 1" SCHEDULE 40 PVC, U.N.O., BURIED MINIMUM 24" BELOW GRADE IN NON-TRAFFIC AREAS.
- VERIFY CLEARANCES WITH ALL UNDERGROUND UTILITIES PRIOR TO INSTALLATION OF ALL UNDERGROUND ELECTRICAL WORK.
- 3. INSTALL A RED WARNING RIBBON OR TAPE, WITH TRACER WIRE, 12" ABOVE ALL UNDERGROUND CONDUITS.
- 4. BRANCH CIRCUIT VOLTAGE DROP SHALL BE 3% MAXIMUM.


KEY NOTES

- EXISTING UNDERGROUND ELECTRICAL BOX WITH EXISTING WIRING COILED UP FROM EXISTING SHELTER HOUSE THAT WAS REMOVED.
- 2. INSTALL NEW 2 1/2" SCHEDULE 40 PVC CONDUIT FROM PANEL A TO EXISTING UNDERGROUND ELECTRICAL BOX FOR PANEL FEEDER. PROVIDE AND INSTALL NEW WIRING FROM PANEL TO EXISTING UNDERGROUND ELECTRICAL BOX. NEW WIRING SHALL BE SAME SIZE AND MATERIAL AS EXISTING WIRING THAT IS IN EXISTING UNDERGROUND ELECTRICAL BOX, IF APPROPRIATE AND ALLOWED BY CODE. VERIFY EXISTING CONDITIONS.
- 3. INSTALL NEW 2" SCHEDULE 40 PVC CONDUIT FROM PANEL A TO EXISTING UNDERGROUND ELECTRICAL BOX FOR BRANCH CIRCUIT(S). PROVIDE AND INSTALL NEW WIRING FROM PANEL TO EXISTING UNDERGROUND ELECTRICAL BOX. NEW WIRING SHALL BE SAME SIZE AND MATERIAL AS EXISTING WIRING THAT IS IN EXISTING UNDERGROUND ELECTRICAL BOX, IF APPROPRIATE AND ALLOWED BY CODE. SEE RISER DIAGRAM ON SHEET E601 AND FIELD VERIFY EXISTING CONDITIONS.

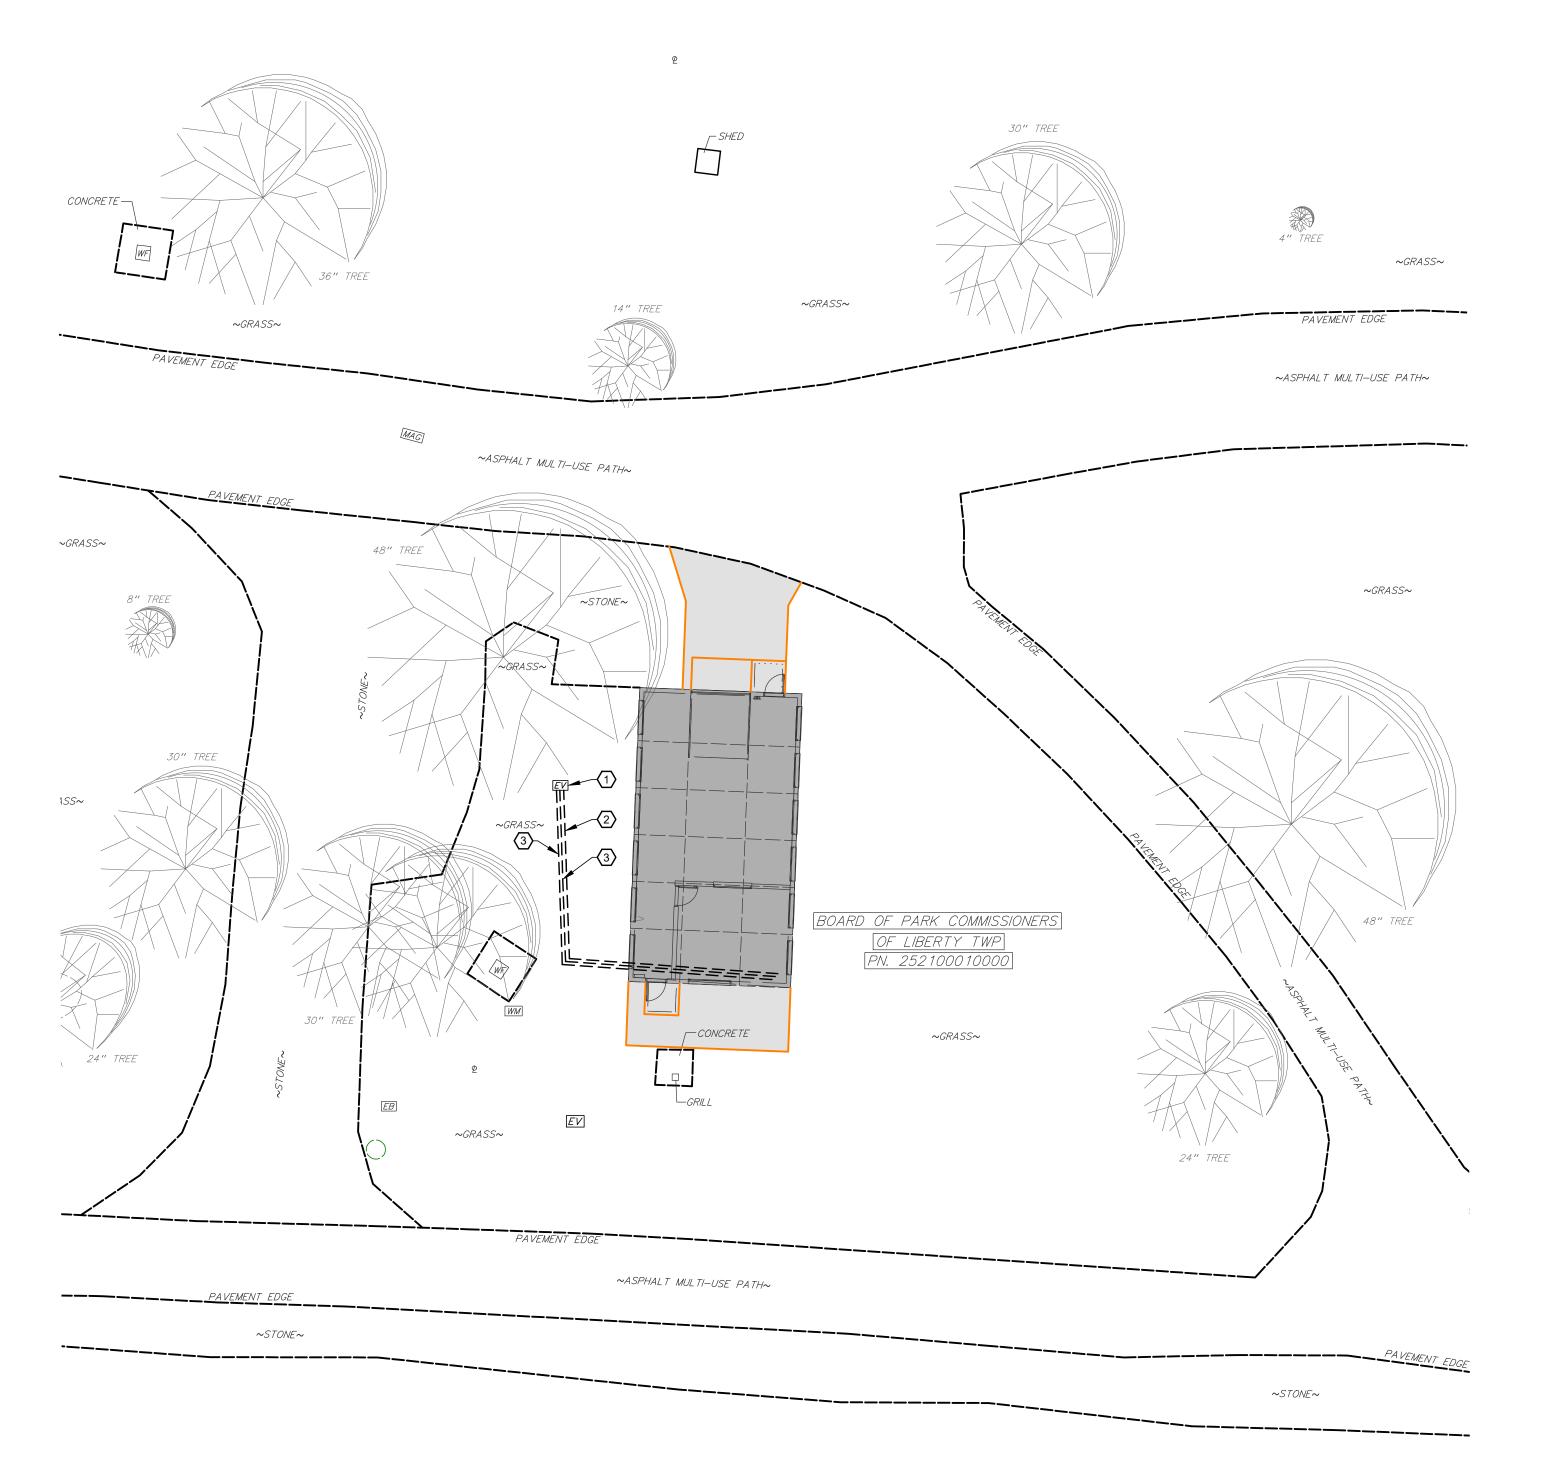





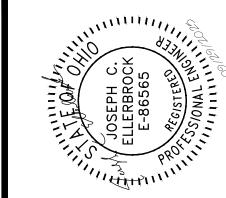

# Design Group

A R C H I T E C T U R E E 202 W. MAIN STREET, SUITE 301,

EW ENCLOSED SHELTER HOUSE

DA WAR MEMORIAL PARK

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ELECTRICAL SITE PLAN

ISSUED DATE
09/29/2025 ADDENDUM #2

DRAWN BY: JE

DATE: 07-25

SHEET SIZE: 24x36

JOB NO. 41-3097-25
SHEET
E100

## GENERAL ELECTRICAL NOTES:

1. THE CONTRACTOR SHALL KEEP COPIES OF DRAWINGS MARKED IN RED TO CLEARLY INDICATE ALL CHANGES MADE AND THE EXACT LOCATIONS OF CONDUITS CONCEALED UNDER CONCRETE OR PAVING. A COPY OF THESE DRAWINGS SHALL BE SENT TO THE OWNER UPON COMPLETION OF THE JOB. THESE DRAWINGS SHALL BE MARKED AS "ELECTRICAL AS-BUILT DRAWINGS"

2. THE MINIMUM SPACING BETWEEN AND THE CLEARANCE AROUND ELECTRICAL PANELS, SAFETY SWITCHES AND CONTACTORS SHALL BE AS REQUIRED BY THE LATEST ADDITION OF THE NATIONAL ELECTRICAL CODE ARTICLE 110.26, TABLE 110.26(A)(1), CONDITIONS 2 AND 3, AS NOTED ON THE DRAWINGS OR AS REQUIRED BY LOCAL ORDINANCES.

## 3. CONDUCTORS SHALL BE AS FOLLOWS:

ALL CONDUCTORS SHALL BE COPPER STRANDED.
 B. ALL CONDUCTORS SHALL BE TYPE "THWN" OR "THHN" UNLESS SHOWN OR NOTED IN
 SPECIFICATIONS OTHERWISE.

4. ALL EQUIPMENT EXPOSED TO THE WEATHER OR WET CONDITIONS SHALL BE NEMA 4X OR NEMA 3R WHERE INDICATED.

5. INSTALL A NEATLY TYPED COPY OF THE APPLICABLE PANEL SCHEDULE INSIDE EACH PANEL DOOR AND PLACE INSIDE A PLASTIC COVER. USE PANEL SCHEDULE SHEETS AS A GUIDE.

6. ALL CONDUIT SHALL HAVE EQUIPMENT GROUND WIRE INCLUDING LIGHTING AND RECEPTACLE CIRCUITS.

7. ALL CONDUITS, APPROVED FOR DIRECT BURIAL, SHALL BE BURIED PER NEC TABLE 300.5 AND SHALL BE A MINIMUM OF 1" IN DIAMETER, UNLESS OTHERWISE NOTED.

8. SPLICES: CONDUCTORS SHALL NOT BE SPLICED EXCEPT IN OUTLETS OR JUNCTION BOXES, TROUGHS, AND GUTTERS OR WIREWAYS. JUNCTION BOXES MAY BE UTILIZED WHERE

9. JUNCTION BOX TO BE SUPPORTED FROM JOISTS OR PURLINS USING BRACKETS LISTED TO MAINTAIN BOX STABILITY WITH CABLE SUSPENDED FROM IT.

10. PROVIDE BONDING FOR ALL METAL RACEWAYS THAT CONTAINS GROUNDING ELECTRODE AS PER LATEST EDITION OF THE NEC, 250.92.

11. CONTRACTOR SHALL VISIT AND SURVEY THE SITE THOROUGHLY TO INSPECT CONDITIONS AFFECTING THE WORK. CONTRACTOR SHALL ASSUME RESPONSIBILITY FOR ALL CONDITIONS INCLUDING BUT NOT LIMITED TO ACCESS AND WORK SPACE LIMITATIONS.

12. E.C. SHALL VERIFY CONDUCTOR SIZES SHOWN ARE SIZED FOR THE RUN LENGTHS FROM PANEL TO PROVIDE POWER WITHIN VOLTAGE DROP LIMITS.

13. FIELD VERIFY DIMENSIONS AND EXACT LOCATIONS OF ALL NEW MATERIALS AND COORDINATE ALL WORK WITH GENERAL CONTRACTOR AND ALL OTHER TRADES PRIOR TO FABRICATING OR INSTALLING ANY WORK.

14. ELECTRICAL CONTRACTOR SHALL COORDINATE FINAL POWER CONNECTIONS FOR ALL MECHANICAL EQUIPMENT & FABRICATING EQUIPMENT WITH THE M.C. & OWNER.

15. ALL LAMPS TO BE SUPPLIED BY FIXTURE SUPPLIER.

16. RECEPTACLE AND SWITCH MOUNTING HEIGHT IS TO BOTTOM OF BOX, U.N.O., SEE PLANS & LEGENDS FOR HEIGHT.

17. ALL BREAKERS USED FOR SWITCHING SHALL BE DUTY RATED.

18. VERIFY VOLTAGE, AMPERAGE, CIRCUITS, WIRE AND CONDUIT SIZE OF ALL FIXTURES AND EQUIPMENT PRIOR TO INSTALLATION.

19. ALL UNDERGROUND GRC OR PVC CONDUIT SHALL BE INSTALLED BY E.C.. E.C. TO INSTALL PER THE LATEST ADDITION OF THE NEC REQUIREMENTS. ALL ELBOWS UP THRU SLAB SHALL BE OF GALVANIZED RIGID CONDUIT (G.R.C.)

20. VERIFY POWER LOADS AT EACH BRANCH CIRCUIT PRIOR TO INSTALLATION.

21. THE ELECTRICAL CONTRACTOR SHALL VERIFY W/ THE OWNER AND G.C. THAT THE LOCAL ZONING AUTHORITY HAS REVIEWED THE DRAWINGS FOR COMPLIANCE W/ ANY LIGHT SPILLAGE OR TRESPASSING ORDINANCES THAT MAY APPLY AT THIS LOCALITY.

## ELECTRICAL ABBREVATIONS


ELECTRICAL CONTRACTOR	E.C.
PLUMBING CONTRACTOR	P.C.
GENERAL CONTRACTOR	G.C.
MECHANICAL CONTRACTOR	M.C.
FIRE PROTECTION CONTRACTOR	F.P.C.
TEMPERATURE CONTROL CONTRACTOR	T.C.C.
AUTHORITY HAVING JURISDICTION	A.H.J.
ABOVE FINISHED FLOOR	A.F.F.
UNLESS NOTED OTHERWISE	U.N.O.
COVER PLATE	C.P.
SURGE PROTECTIVE DEVICE	SPD
NATIONAL ELECTRIC CODE	NEC
NIGHT LIGHT	NL
COPPER CONDUCTORS	CU
ALUMINUM CONDUCTORS	ALUM
ARC-FAULT CIRCUIT INTERRUPTER	AFCI
GROUND-FAULT CIRCUIT INTERRUPTER	GFCI
WEATHERPROOF	WP
CONCRETE MASONRY UNIT	CMU
OVERHEAD CONDUIT	
UNDERGROUND CONDUIT	

ELECTRICAL BRANCH CIRCUITS (1Ø)					
AMP/VOLT/PHASE	WIRE (CU) & CONDUIT (EMT)				
20/120/1	2 #12 THHN WIRES W/ #12 GRD. IN 1/2"C. MIN.				
20/240/1	3 #12 THHN WIRES W/ #12 GRD. IN 1/2"C. MIN.				
30/240/1	3 #10 THHN WIRES W/ #10 GRD. IN 1/2"C. MIN.				
40/240/1	3 #8 THHN WIRES W/ #10 GRD. IN 3/4"C. MIN.				
50/240/1	3 #6 THHN WIRES W/ #10 GRD. IN 3/4"C. MIN.				
240V WIRE SIZE AS NOTED OR PER AMPERAGE REQUIRED WITH GROUND, 2 POLE WIRES AS PER NEC					

## 

3 B A-25

- EXISTING PANEL FROM DEMOLISHED SHELTER HOUSE TO BE REUSED.
  COORDINATE WITH OWNER.
- 2. MOUNT AT 112" A.F.F.
- 3. MOUNT ABOVE OVERHEAD DOOR.

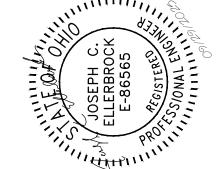

0

## ING DESIGN 375 P:419.523.5323

E N G I N E E R I N G . D E S 1, OTTAWA, OH 45875 P:419.523.53

ITECTURE ENGINE AIN STREET, SUITE 301, OTTAWA,

A R C H I T E C T U R E 202 W. MAIN STREET, SUII www.technicondesigngroup.

ENCLOSED SHELTER HOUSE
WAR MEMORIAL PARK

101 N. PARK DRIVE

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ELECTRICAL GENERAL NOTES LIGHTING PLAN POWER PLAN

ISSUED DATE

09/09/2025 PERMITS / BIDDING

09/29/2025 ADDENDUM #2

DRAWN BY:	,
DATE:	07-


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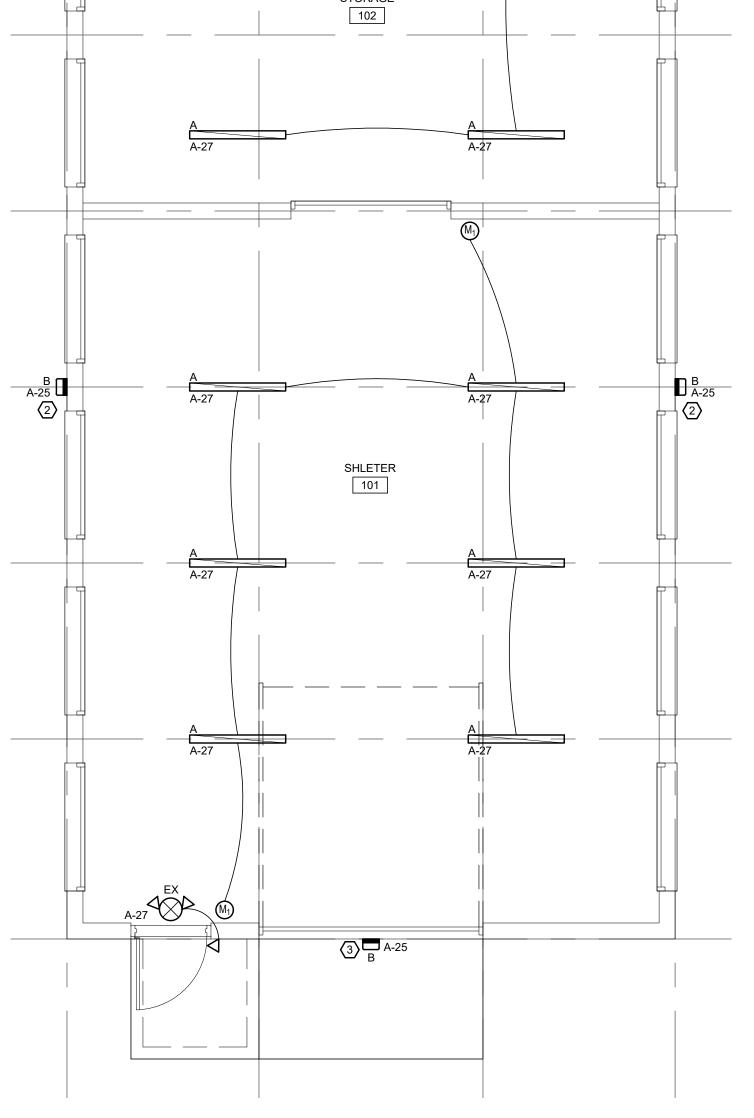
 DATE:
 07-25

 SHEET SIZE:
 24x36

 JOB NO.
 41-3097-25

SHEET **E101** 



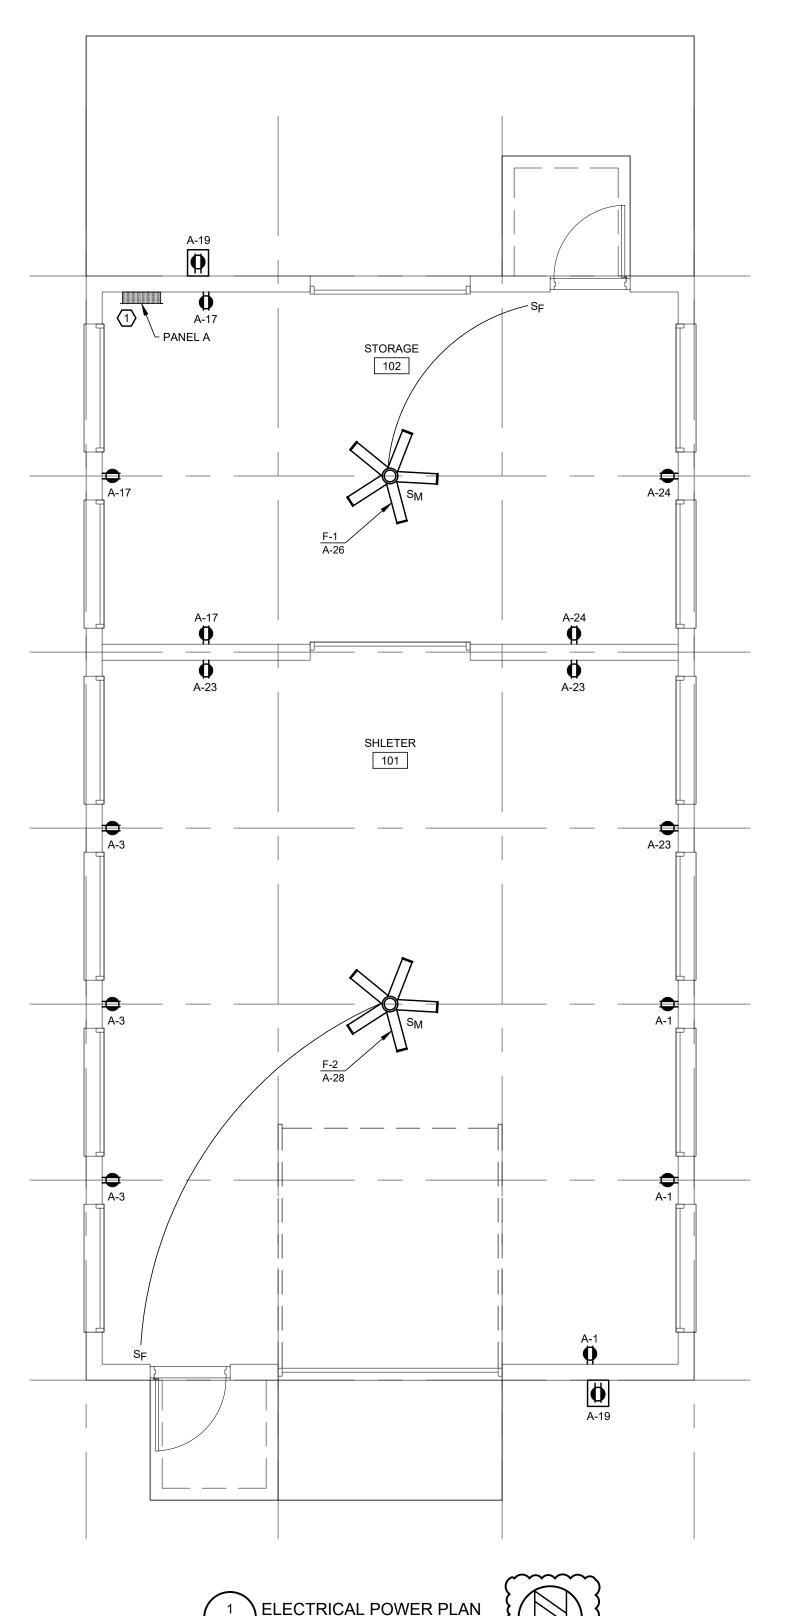

LECTRICAL LIGHTING PLAN

	POWER LEGEND									
TYPE	DESCRIPTION	MFR	MODEL	MOUNTING HEIGHT (A.F.F.)	COVER PLATE COLOR	V	PH	AMPS	NEMA	NOTES
Ø	DUPLEX GFCI RECEPTACLE	HUBBELL OR EQUAL	GFRTW20I	16" U.N.O.	IVORY	120	1	20		1,2,3
•	GFCI RECEPTACLE W/ IN-USE COVER	HUBBELL OR EQUAL	GFRTW20I	24"	CLEAR OR GRAY	120	1	20		1,2,3,4
s <sub>M</sub>	MOTOR-CIRCUIT SWITCH	SQUARE D OR EQUAL	**	-	-		1	-		5
S <sub>F</sub>	FAN MOTOR SPEED CONTROLLER	QMARK OR APPROVED EQUAL	CTL12004RSPD	44"	IVORY	120	1	5		7
*	CEILING FAN (FAN SIZE 56")	LEADING EDGE	56201 CLS	11-'4"	WHITE	120	1	1		6,7
NOTES	LEGEND						L			

4 INSTALL WEATHER-RESISTANT GFCI RECEPTACLE IN CAST ALUMINUM BOX W/ EXTRA DUTY LISTED WEATHERPROOF WHILE-IN-USE COVER
5 HORSEPOWER RATED WITH OVERCURRENT PROTECTION (IF REQUIRED). SEE PLAN FOR VOLTAGE REQUIREMENT

1 E.C. TO VERIFY DEVICE COLOR AND/OR COVER PLATE WITH OWNER


7 INSTALL FAN AND CONTROLLER ACCORDING TO MANUFACTURER'S INSTRUCTIONS

2 RECEPTACLE SHALL BE TAMPER-RESISTANT 3 RECEPTACLE SHALL BE WEATHER-RESISTANT

6 CEILING FAN SHALL BE DAMP RATED.

TYPE	MARK	DESCRIPTION	MFR AND MODEL	MOUNTING	FINISH	LAMPS		COLOR		NOTES
						V	TYPE	TEMP.	WATTAGE	
	А	4' LED LINEAR	LITHONIA: CSS L48 AL03 MVOLT SWW3 80CRI METALUX: 4SLSTPSLC-UNV DAY-BRITE: SDS42550LCST-UNV-DIM	SURFACE MOUNT	WHITE	120	LED	4000	46W	1,3,5
	В	LED WALL LUMINAIRE	LITHONIA: TWX2 LED ALO 50K MVOLT PE DDBXD LUMECON: LDS-FT-55-WH-1-CW-R OR APPROVED EQUAL BY ARCHITECT	WALL - SEE PLAN	WHITE	120	LED	5000	54W	1,4,5
48€3	EX	LED EXIT/EMERG. FIXTURE	LITHONIA: ECBR LED M6 ISOLITE: RLP-R-U-WH-MTEB EXITRONIX: CLED-U-WH	CEILING/WALL	WHITE	120	LED	-	3W	2,3
4	EM	LED EMERGENCY FIXTURE	LITHONIA: ELM2L ISOLITE: BUG 3W WH EXITRONIX: LED -52-WH	SURFACE - WALL	WHITE	120	LED	-	1.09W	6
NOTES	LEGE									
1		S BY FIXTURE SUPPLIER								
			REMOTE HEAD (COMPATIBLE WITH EXIT LIGHT)							
3	<b></b>	LOCATION LISTED								
4		OCATION LISTED DINATE WITH OWNER FOR LU	IMEN OUTDUIT SETTING							
	<del> </del>	T 7'-6" A.F.F.	JIMEN OUTPUT SETTING					***************************************		***************************************
6	<del> </del>	17-0 A.I.I.								


TYPE	DESCRIPTION	MFR	MODEL	MOUNTING	Cover Plate	V	РΗ	Amps	NOTES
	······································	·····		WEIGHT (A.F.F.)		<b>~~</b>	~	···	~~~
s <sub>1</sub>	SINGLE POLE SWITCH	HUBBELL OR EQUAL	CS120I	44"	IVORY	120	1	20	1
		-SENSORWORXOR-	~~~~~				$\sim$	~~~	~~~
$ W_1\rangle$	OCCUPANCY SENSOR (PIR)	EQUAL	SWX-101-IV	44"	IVORY	120	1	6.67	1
	(X) INDICATES LIGHTING FIXTURE MARK. SEE LIGHT FIXTURE SCHEDULE			SEE PLAN					
NOTES	LEGEND								

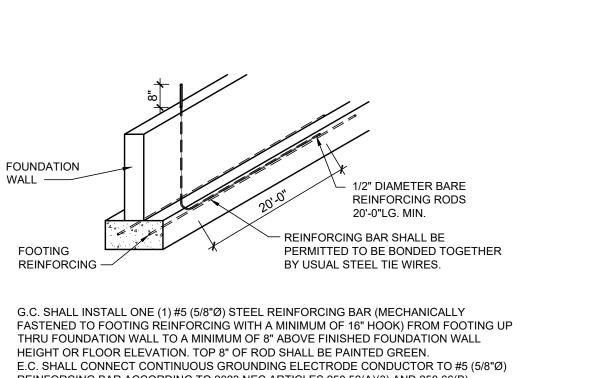

REINFORCING BAR ACCORDING TO 2023 NEC ARTICLES 250.52(A)(3) AND 250.66(B). G.C. TO COORDINATE LOCATION WITH E.C. PRIOR TO INSTALLATION.

ALSO SEE FOUNDATION DRAWINGS.

2	GROUNDING DETAIL
E501	SCALE: N.T.S.

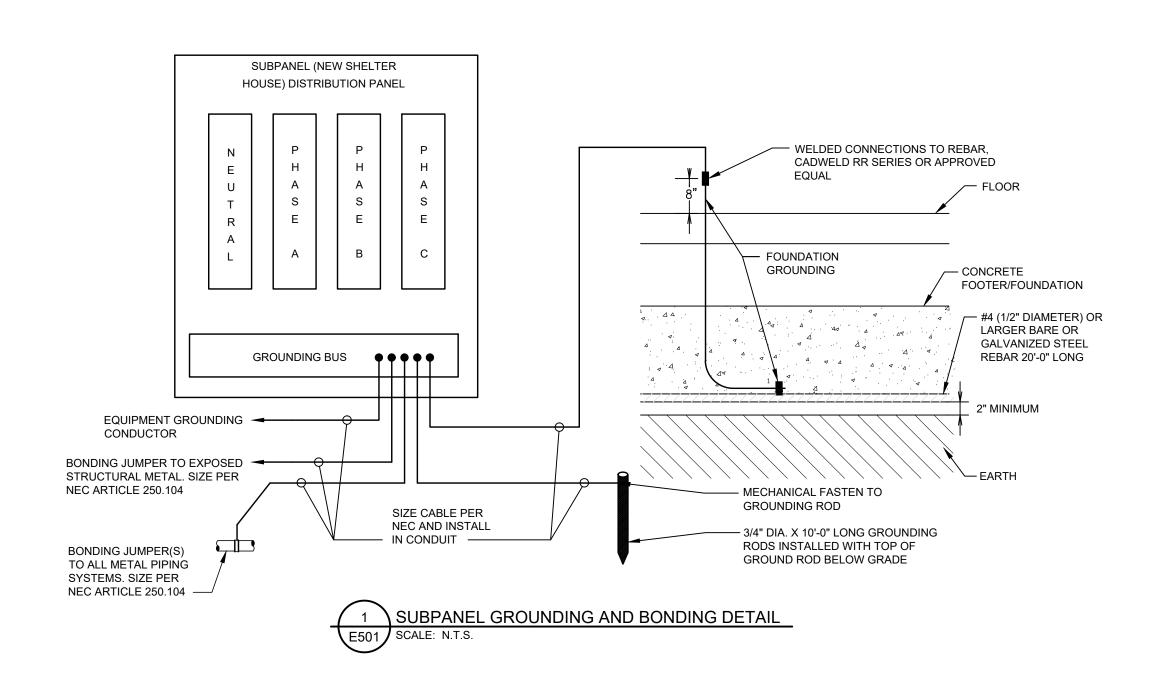

HOUSE ENCLOSED ME WAR

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LEGENDS DETAILS **ISSUED DATE** 

09/09/2025 PERMITS / BIDDING 09/29/2025 ADDENDUM #2

DRAWN BY:

07-25 DATE: SHEET SIZE: 24x36

JOB NO. 41-3097-25 SHEET E501

E.C. TO MOUNT PHOTOCELL ON NORTH EXTERIOR WALL E.C. TO MOUNT TIME CLOCK ON WALL BY ELECTRICAL PANEL A

TIMER/LIGHTING CONTROL/SWITCH RISER

T-1 PH-1 EXTERIOR LIGHTS

MULTI-PURPOSE 365 DAY DIGITAL TIME CLOCK, 120-277V,

TORK OR EQUAL. T-1 SHALL HAVE A MINIMUM OF FOUR

CHANNELS FOR SEPARATE ON-OFF TIMES OF EXTERIOR

STEM MOUNTED PHOTOCELL CONTROL SWITCH W/ LIGHT LEVEL SLIDE ADJUSTMENT, J-BOX MOUNTED UNDER SOFFIT, 20A.,

120V., HEAVY DUTY DIE CAST HOUSING, INTERMATIC OR EQUAL

A-29

SYMBOL LEGEND